


BUILDING SET BACK AND BUILDING SEPARATION (PNAP APP-152)

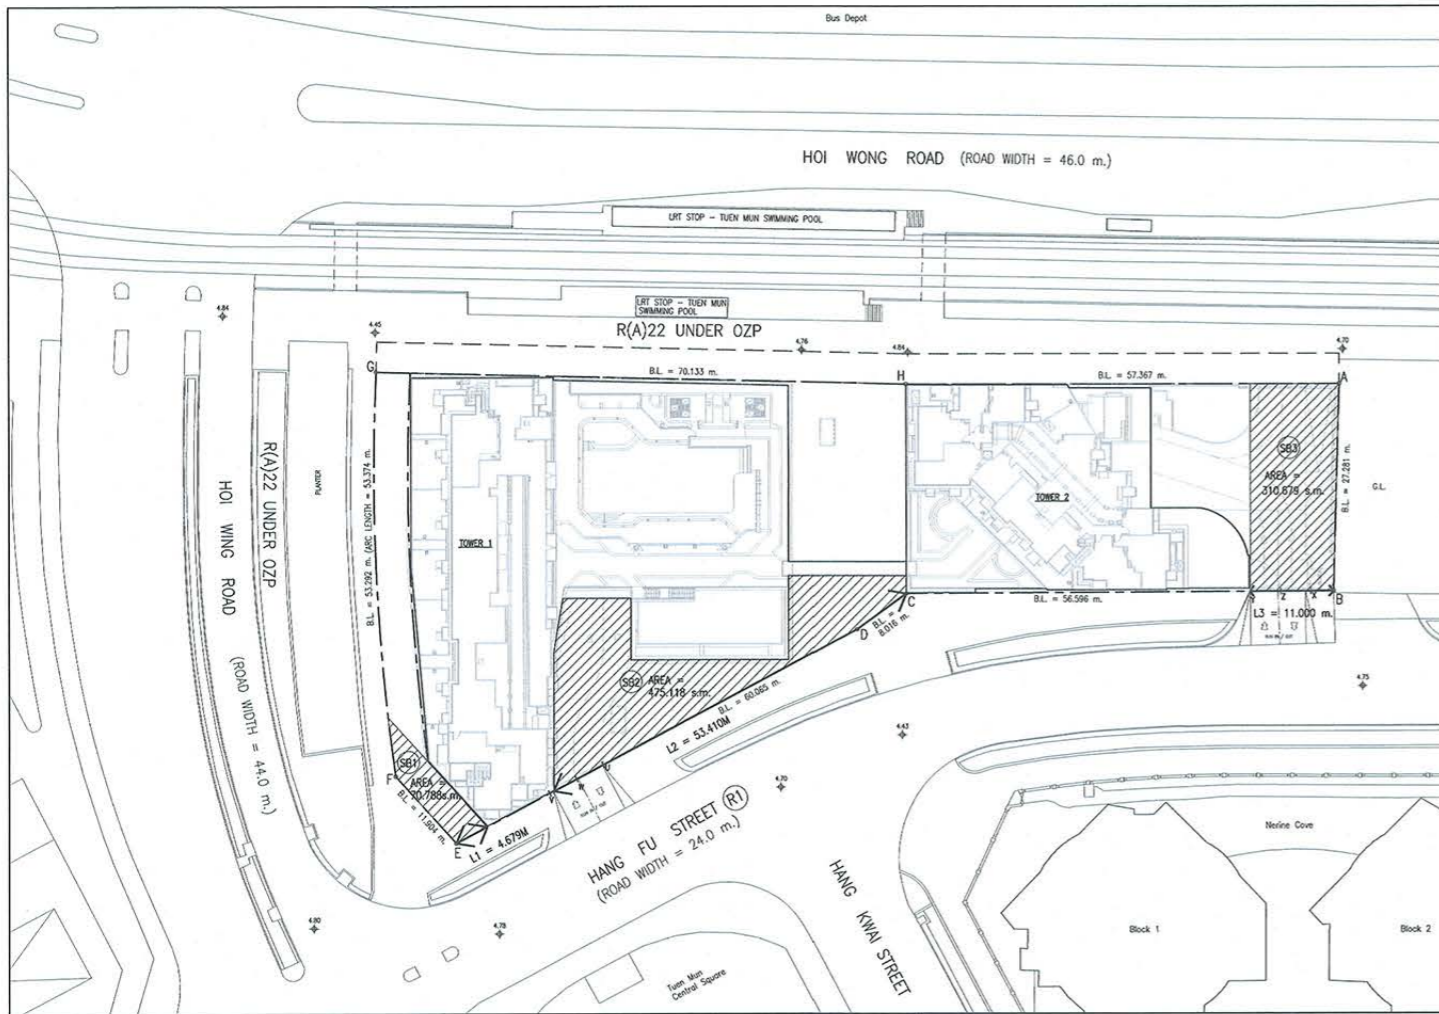

SUSTAINABLE BUILDING DESIGN (SBD)

SITE AREA = 4831 s.m. (ABOUT) < 20000 s.m.  
 CLASS = 'A'  
 BUILDING HEIGHT (T1) = 98.900 m. - 4.70 m. (MEAN LEVEL) = 93.900 m. > 60 m.  
 (T2) = 92.600 m. - 4.70 m. (MEAN LEVEL) = 87.900 m. > 60 m.

BUILDING SET BACK

WIDTH OF (R) ROAD = ABOUT 24.000 m. < 15 m.  
 THEREFORE, NO BUILDING SET BACK IS REQUIRED UNDER S.B.D. GUIDELINES

BUILDING SEPARATION ASSESSMENT - LOW ZONE

SITE COVERAGE  
 COVERED AREA OF THE BUILDING = 3039.411 s.m.  
 (i.e. 3039.411 s.m. / 4831 s.m. x 100% = 62.915 %)  
 SITE COVERAGE ABOVE GROUND LEVEL = 62.915% (NOT EXCEEDING 65%)

AREA OF BUILDING SETBACK


TOTAL AREA OF BUILDING SET BACK = (SB1) + (SB2) + (SB3)  
 = 70.788 s.m. + 475.118 s.m. + 310.679 s.m.  
 = 856.585 s.m.  
 (i.e. 856.585 s.m. / 4831 s.m. x 100% = 17.731 % > 15%)

FRONTAGE OF BUILDING SETBACK

LENGTH OF SITE BOUNDARY ABUTTING HANG FU STREET = 124.677M  
 TOTAL FRONTAGE OF BUILDING SETBACK ALONG HANG FU STREET  
 = 4.679M + 53.410M + 11.007M  
 = 69.096M (i.e. 55.414% > 50% OF SITE BOUNDARY ABUTTING ON HANG FU STREET)

THEREFORE, THE BUILDING SEPARATION REQUIREMENT AT LOW ZONE CAN BE WAIVED.

SITE PLAN SHOWING FRONTAGE AND AREA OF SET BACK

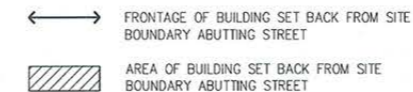

REQUIRED S.C. OF GREENERY

MIN. S.C. OF GREENERY (PRIMARY ZONE) = 10% (483.100 s.m.)  
 TOTAL GREENERY AREA = 20% (966.200 s.m.)  
 MAX. AREAS FOR OTHER GREENING FEATURES = 966.200 s.m. x 30% = 289.860 s.m.

PROVIDED S.C. OF GREENERY (GROUND FLOOR)

PLANTER (A)	= 74.264 s.m.
PLANTER (B)	= 0.928 s.m.
PLANTER (C)	= 31.715 s.m.
PLANTER (D)	= 2.825 s.m.
PLANTER (E)	= 1.148 s.m.
<b>TOTAL</b>	<b>= 110.880 s.m.</b>
DEDUCT	
2x PLINTH (P1) 0.160 x 2	= 0.320 s.m.
3x PLINTH (P2) 0.063 x 3	= 0.189 s.m.
1x PLINTH (P3) 0.090 x 1	= 0.090 s.m.
<b>TOTAL</b>	<b>= 110.281 s.m.</b>

PROVIDED S.C. OF GREENERY (1st FLOOR)

PLANTER (1)	= 43.674 s.m.
PLANTER (2)	= 120.193 s.m.
PLANTER (3)	= 10.638 s.m.
<b>TOTAL</b>	<b>= 174.511 s.m.</b>
DEDUCT	
1x PLINTH (P1) 0.160 x 1	= 0.160 s.m.
3x PLINTH (P2) 0.063 x 3	= 0.189 s.m.
1x PLINTH (P3) 0.090 x 1	= 0.090 s.m.
<b>TOTAL</b>	<b>= 174.072 s.m.</b>

PROVIDED S.C. OF GREENERY (2nd FLOOR)

PLANTER (A) = 57.920 s.m.	PLANTER (J) = 8.788 s.m.	PLANTER (S) = 17.071 s.m.
PLANTER (B) = 1.336 s.m.	PLANTER (K) = 11.796 s.m.	PLANTER (T) = 16.305 s.m.
PLANTER (C) = 7.655 s.m.	PLANTER (L) = 6.094 s.m.	PLANTER (U) = 18.804 s.m.
PLANTER (D) = 1.890 s.m.	PLANTER (M) = 11.532 s.m.	PLANTER (V) = 10.613 s.m.
PLANTER (E) = 5.065 s.m.	PLANTER (N) = 5.329 s.m.	PLANTER (W) = 84.180 s.m.
PLANTER (F) = 1.503 s.m.	PLANTER (O) = 2.804 s.m.	PLANTER (X) = 28.594 s.m.
PLANTER (G) = 25.426 s.m.	PLANTER (P) = 12.823 s.m.	PLANTER (Y) = 23.466 s.m.
PLANTER (H) = 27.110 s.m.	PLANTER (R) = 10.063 s.m.	
<b>TOTAL</b>	<b>= 396.300 s.m.</b>	

DEDUCT	
4x PLINTH (P1) 0.160 x 4	= 0.640 s.m.
33x PLINTH (P2) 0.063 x 33	= 2.079 s.m.
6x PLINTH (P3) 0.090 x 6	= 0.540 s.m.
<b>TOTAL</b>	<b>= 393.041 s.m.</b>

PROVIDED VERTICAL GREENING ON G/E

VERTICAL GREENING (A) = 14.006 s.m.	VERTICAL GREENING (C) = 47.355 s.m.
VERTICAL GREENING (B) = 25.975 s.m.	
<b>TOTAL</b>	<b>= 87.336 s.m.</b>

PROVIDED VERTICAL GREENING ON 1/F

VERTICAL GREENING (A) = 51.199 s.m.	VERTICAL GREENING (B) = 39.528 s.m.
VERTICAL GREENING (C) = 57.133 s.m.	VERTICAL GREENING (D) = 2.977 s.m.
<b>TOTAL</b>	<b>= 160.837 s.m.</b>

PROVIDED VERTICAL GREENING ON 2/F

VERTICAL GREENING (A) = 41.289 s.m.	
<b>TOTAL VERTICAL GREENING</b>	<b>= 41.289 s.m.</b>

ACTUAL VERTICAL GREENING = 289.462 s.m. < 289.860 s.m.

TOTAL PROPOSED S.C. OF GREENERY (PRIMARY ZONE)



= 110.281 s.m. + 174.072 s.m. + 393.041 s.m. + 289.462 s.m.  
 = 966.856 s.m. > 483.100 s.m.

TOTAL PROPOSED S.C. OF GREENERY (OVERALL)

= 110.281 s.m. + 174.072 s.m. + 393.041 s.m. + 289.462 s.m.  
 = 966.856 s.m. > 966.200 s.m.

\* ALL GREENERY AREAS ARE DESIGNATED AS COMMON AREA  
 \* THE TOTAL PROPOSED S.C. OF GREENERY (PRIMARY ZONE) SHALL REFER TO THOSE GREENERY AREA BEING "VISIBLE TO PEDESTRIANS OR ACCESSIBLE BY ANY PERSON OR PERSONS ENTERING THE LOT" AS REQUIRED UNDER SPECIAL CONDITION NO. 9(b)(ii).

SITE COVERAGE OF GREENERY (PNAP APP-152)

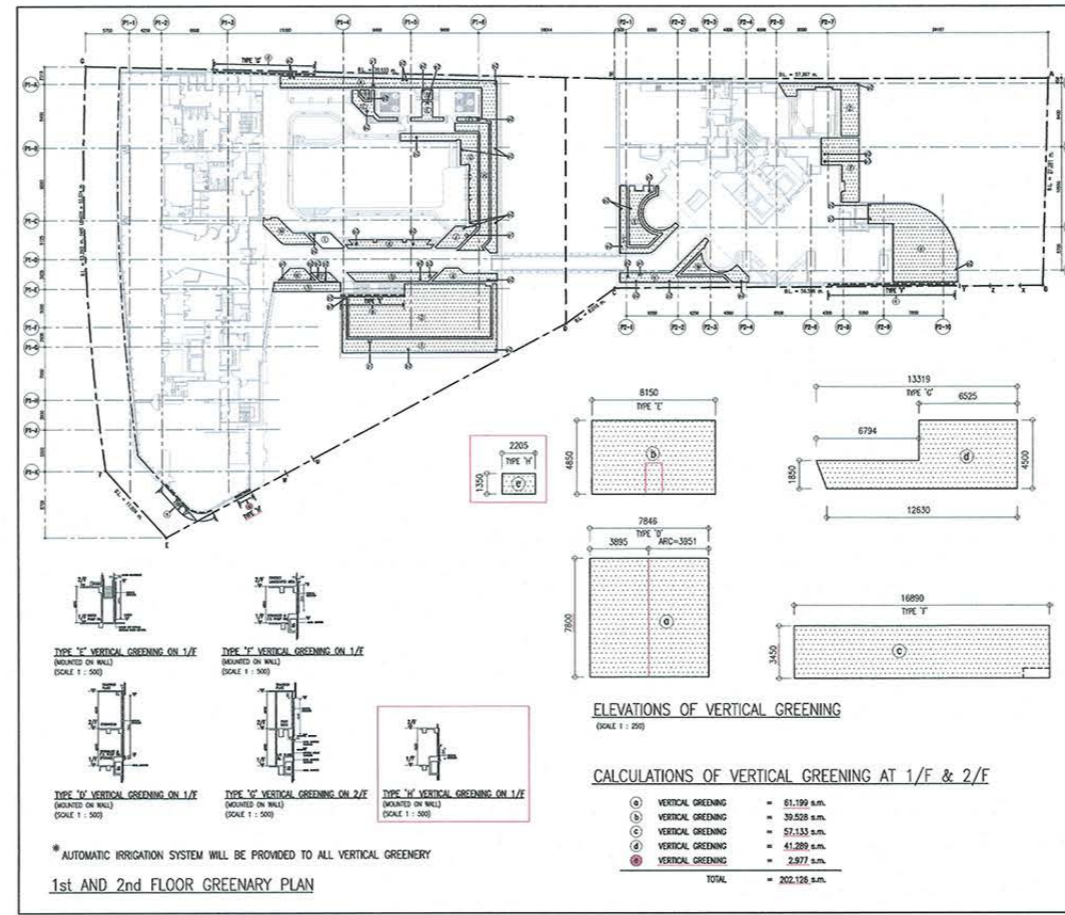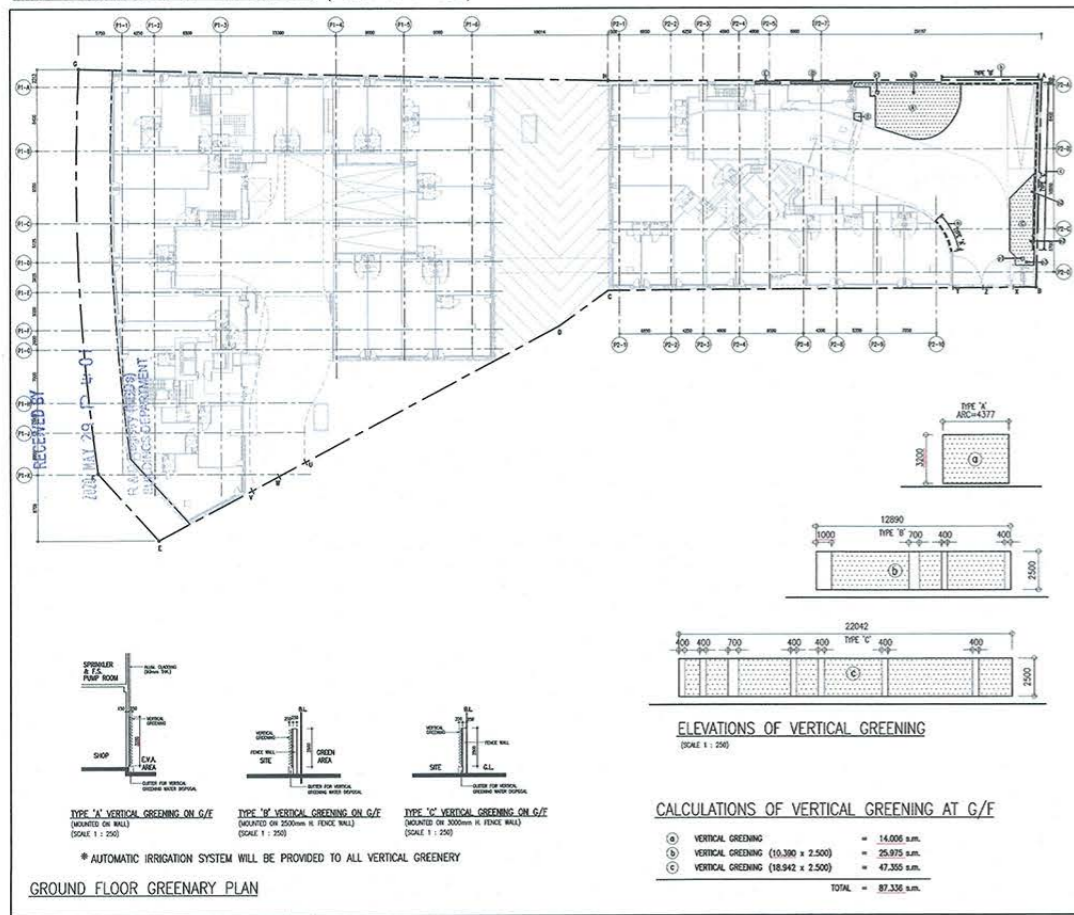

B.D. REF. 2/9162/15

F.S.D. REF. FP 8/30766

REVISIONS :

NUMBER	DESCRIPTION	DATE
-	FIRST SUBMISSION	SEP, 2015
-	RE-SUBMISSION	MAY, 2016
A	GENERAL REVISION	JAN, 2017
B	GENERAL REVISION	AUG, 2017
C	GENERAL REVISION	SEP, 2018
D	GENERAL REVISION	AUG, 2019
E	GENERAL REVISION	FEB, 2020
F	GENERAL REVISION	MAY, 2020

The works shown on these plans are Type II works  
 BUILDING AMENDMENT WORKS  
 in respect of which consent is applied for the purpose of Fast Track consent application under regulation 33 of the Building (Administration) Regulations.  
 First consent Date: 14 JAN 2020

B. D.

AMENDED PLAN  
 DATE : 29 MAY 2020

**SUN HUNG KAI**  
 ARCHITECTS AND ENGINEERS LIMITED  
 SUN HUNG KAI CENTRE, WANCHAI, HONGKONG  
 TEL. 28278111 FAX 28272884

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PROPOSED RESIDENTIAL & COMMERCIAL DEVELOPMENT ON T.M.T.L. No. 539, HOI WING ROAD AND HANG FU STREET, AREA 16, TUEN MUN, N.T.

DRAWING TITLE  
 SBD CALCULATIONS (1)

FILE NAME : TMTL539/BD/31.DWG

DRAWN BY : RY

CHECKED BY : RY

PRINTED DATE : 06 - 2017

SCALE : 1 : 500



JOB NO.	DRAWING NO.	REV.
	B-31	F

ARCHITECT / R.S.E.  
 Wong Ng-shan, Carmel  
 1003  
 Registered Architect  
 Authorized Person (Architect)

FOR APPROVAL USE

Plan Approved  
 NG Lai-shan  
 Senior Building Surveyor  
 for BUILDING AUTHORITY  
 26 JUN 2020

This plan has been processed on a centralized check basis under the centralized processing system as promulgated in PNAP ADM-19. The duties of the authorized registered structural engineer and/or registered geotechnical engineer concerned as specified under section 4(3)(b) and the provision of section 14(2)(c) of the Buildings Ordinance are of particular relevance in this regard.

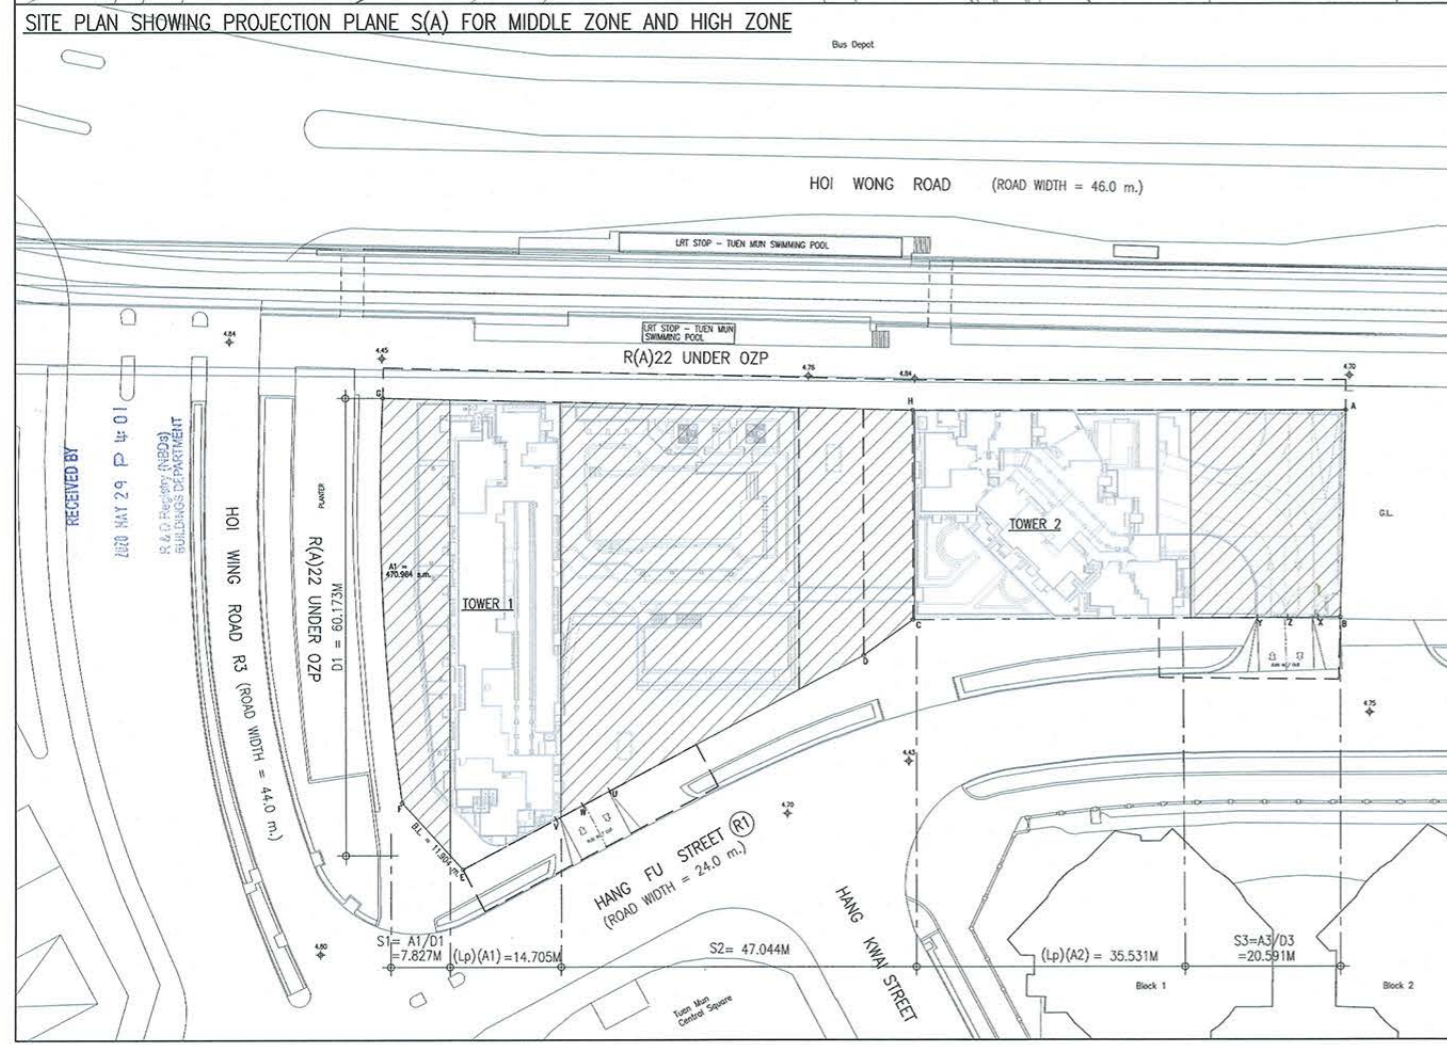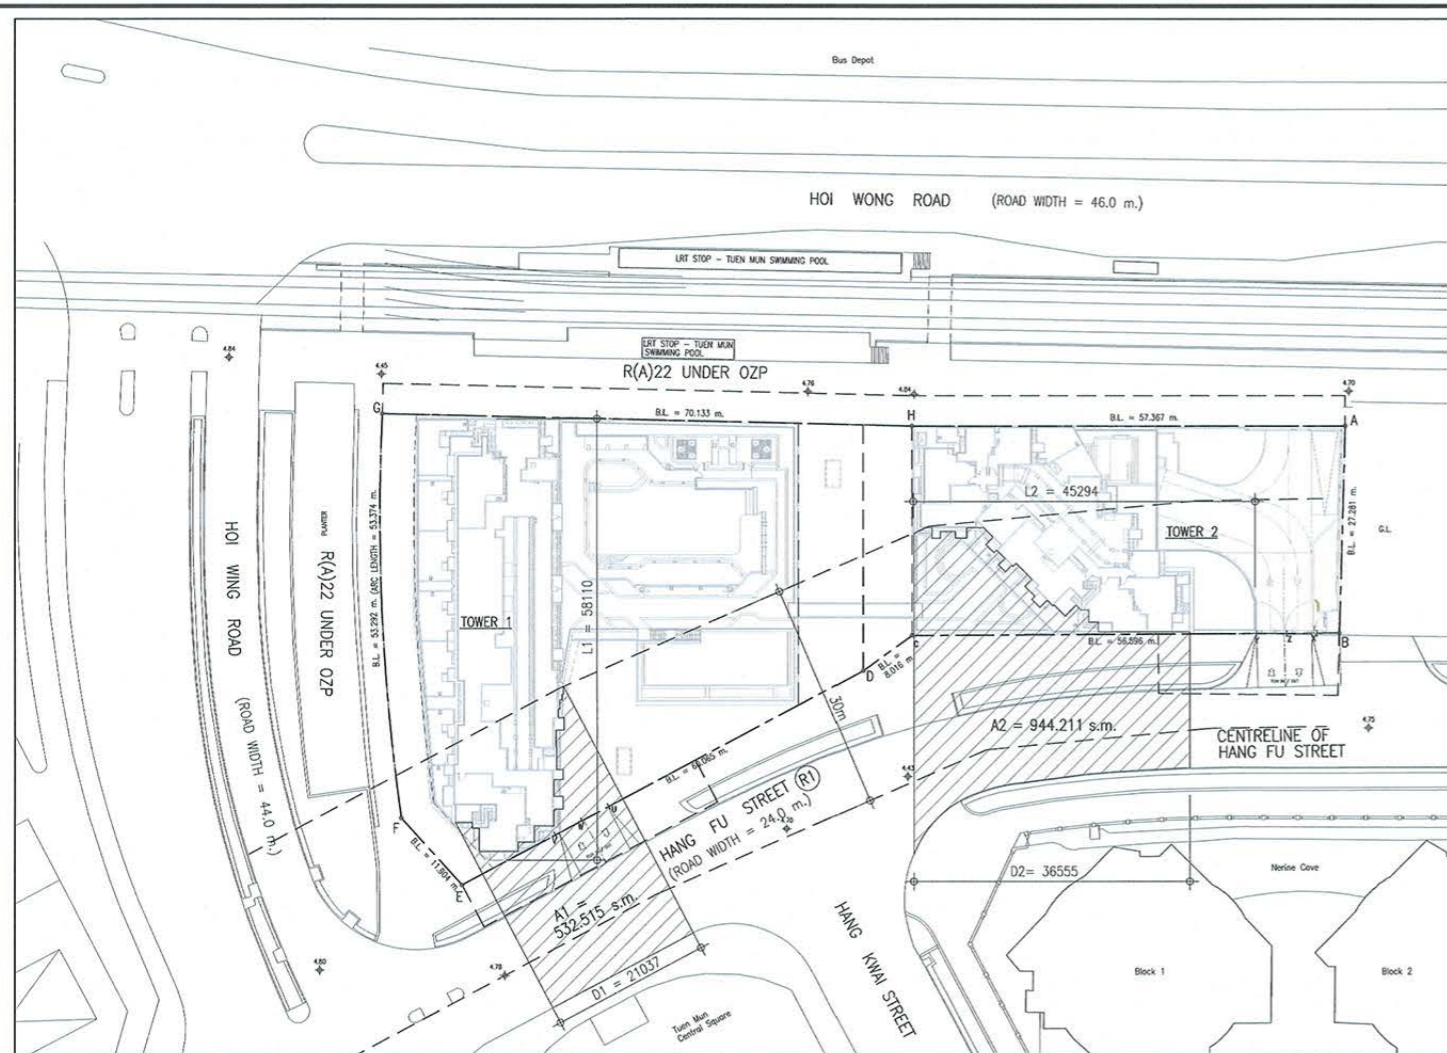

**BUILDING SEPARATION ASSESSMENT : DESIGN REQUIREMENT (1)**  
 CONTINUOUS PROJECTED FACADE LENGTH (Lp) OF MIDDLE ZONE & HIGH ZONE  
 UA1 = 532.515 s.m. / 21.037 m. = 25.313 m.  
 UA2 = 944.211 s.m. / 36.555 m. = 25.830 m.  
 MAX. PERMISSIBLE (Lp)A1 = 5 x 25.313 m. = 126.565 m. > 58.110 m. (PROPOSED) (i.e. COMPLIED)  
 MAX. PERMISSIBLE (Lp)A2 = 5 x 25.830 m. = 129.150 m. > 45.294 m. (PROPOSED) (i.e. COMPLIED)

**BUILDING SEPARATION ASSESSMENT : DESIGN REQUIREMENT (2) - MIDDLE ZONE & HIGH ZONE**  
 SEPARATING DISTANCE (S) & PERMEABILITY (P) PROJECTION X OF MIDDLE ZONE  
 TOTAL FACADE AREA OF THE INTERVENING SPACES  
 (7.827 x 40) s.m. + (47.044 x 40) s.m. + (20.593 x 40) s.m.  
 = 3018.56 s.m.  
 OVERALL (P) ACHIEVED  
 3018.56 s.m. / (125.699 x 40) s.m. x 100%  
 = 60.035 % > 20 % (i.e. COMPLIED)

SEPARATING DISTANCE (S) & PERMEABILITY (P) PROJECTION X OF HIGH ZONE  
 TOTAL FACADE AREA OF THE INTERVENING SPACES  
 (7.827 x 34.2) s.m. + (47.044 x 34.2) s.m. + (20.593 x 34.2) s.m.  
 = 2580.766 s.m.  
 OVERALL (P) ACHIEVED  
 2580.766 s.m. / (125.699 x 34.2) s.m. x 100%  
 = 60.035 % > 20 % (i.e. COMPLIED)

DIAGRAM OF A&D FOR STREET CANYON (U)

Note: This plan has been processed on a digital check basis under the automated processing system as promulgated in PMAP ADM-19. The duties of the authorized person, registered structural engineer and/or registered geotechnical engineer concerned as specified under section 4(3)(b) and the provision of section 14(2)(c) of the Buildings Ordinance are of particular relevance in this regard.

B.D. REF. 2/9162/15  
 F.S.D. REF. FP 8/30766

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B. D.

AMENDED PLAN  
 DATE : 29 MAY 2020

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PROJECT  
 PROPOSED RESIDENTIAL & COMMERCIAL DEVELOPMENT ON T.M.T.L. No. 539, HOI WONG ROAD AND HANG FU STREET, AREA 16, TUEN MUN, N.T.

DRAWING TITLE  
 SBD CALCULATIONS (2)


FILE NAME : T\MTL539\B0B-32.DWG  
 DRAWN BY : RY  
 CHECKED BY : RY  
 PRINTED DATE : 08 - 2017  
 SCALE : 1 : 500

JOB NO.	DRAWING NO.	REV.
	B-32	F

ARCHITECT / R.S.E.  
  
 Wong Ka-han, Charman  
 1914  
 Registered Architect  
 Authorized Person (A/2014)

FOR APPROVAL USE

Plan Approved  
  
 NG Lai-shan  
 Senior Building Surveyor  
 for BUILDING AUTHORITY  
 26 JUN 2020

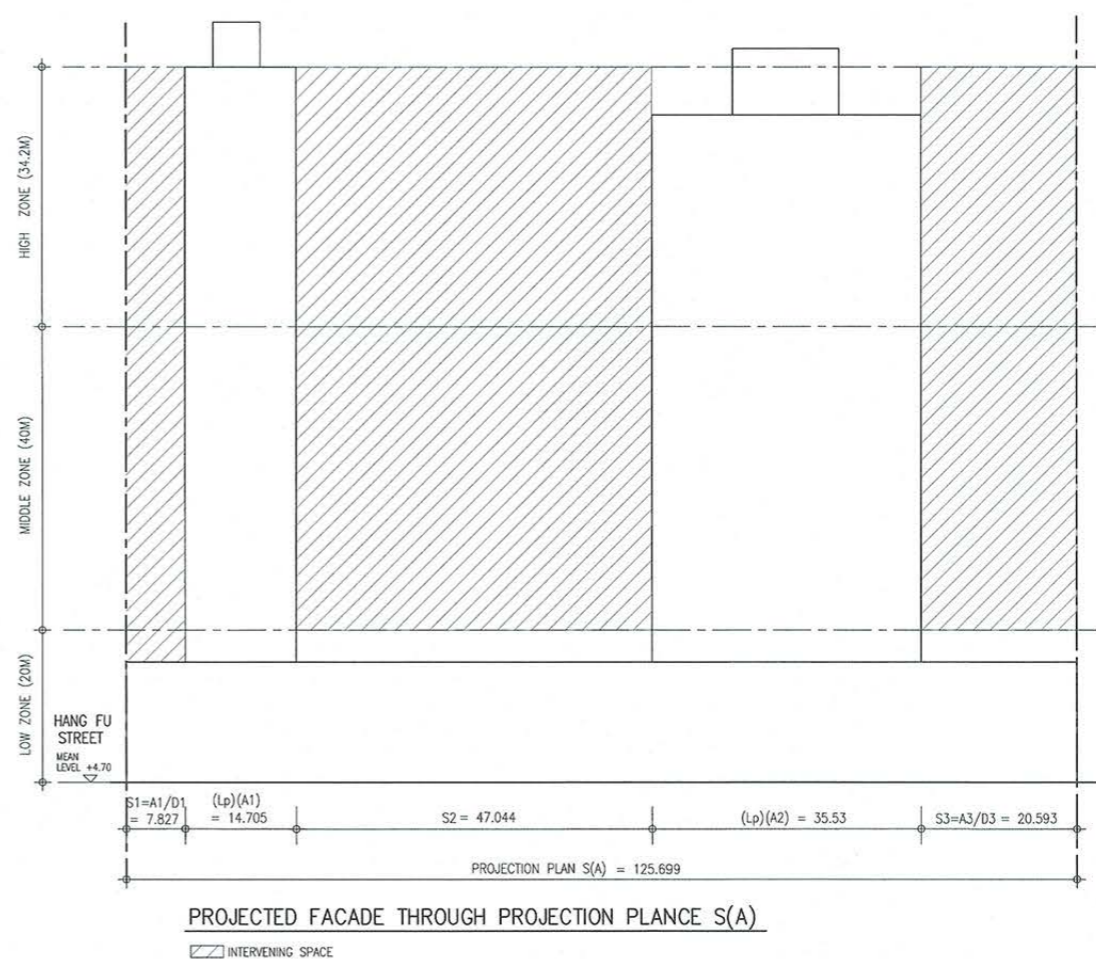

PROJECTED FACADE THROUGH PROJECTION PLANE S(A)  
 ▨ INTERVENING SPACE