

SITE COVERAGE DIAGRAM OF GREENERY
1:500

GREENERY AREA CALCULATION

① = 24.84 m ²	① = 4.54 m ²	① = 102.19 m ²	① = 172.50 m ²	① = 11.76 m ²	① = 166.00 m ²
② = 23.80 m ²	② = 8.18 m ²	② = 53.91 m ²	② = 172.50 m ²	② = 48.20 m ²	② = 166.00 m ²
③ = 2.80 m ²	③ = 10.81 m ²	③ = 13.81 m ²	③ = 15.14 m ²	③ = 27.26 m ²	③ = 6.14 m ²
④ = 77.14 m ²	④ = 13.81 m ²	④ = 5.78 m ²	④ = 26.56 m ²	④ = 11.57 m ²	④ = 6.14 m ²
⑤ = 10.41 m ²	⑤ = 5.78 m ²	⑤ = 5.78 m ²	⑤ = 70.40 m ²	⑤ = 2.00 m ²	⑤ = 6.14 m ²
⑥ = 201.80 m ²	⑥ = 4.18 m ²	⑥ = 5.94 m ²	⑥ = 70.40 m ²	⑥ = 2.00 m ²	⑥ = 6.14 m ²
⑦ = 271.81 m ²	⑦ = 5.94 m ²	⑦ = 78.11 m ²	⑦ = 143.74 m ²	⑦ = 21.87 m ²	⑦ = 6.14 m ²
⑧ = 119.74 m ²	⑧ = 78.11 m ²	⑧ = 10.57 m ²	⑧ = 39.40 m ²	⑧ = 15.24 m ²	⑧ = 47.20 m ²
⑨ = 18.71 m ²	⑨ = 10.57 m ²	⑨ = 10.57 m ²	⑨ = 10.57 m ²	⑨ = 43.31 m ²	⑨ = 6.14 m ²
⑩ = 8.24 m ²	⑩ = 10.57 m ²	⑩ = 10.57 m ²	⑩ = 10.57 m ²	⑩ = 126.49 m ²	⑩ = 6.14 m ²
⑪ = 101.88 m ²	⑪ = 10.57 m ²	⑪ = 10.57 m ²	⑪ = 10.57 m ²	⑪ = 10.57 m ²	⑪ = 2.50 m ²
⑫ = 233.14 m ²	⑫ = 10.57 m ²	⑫ = 58.33 m ²	⑫ = 50.40 m ²	⑫ = 10.57 m ²	⑫ = 6.14 m ²
⑬ = 40.83 m ²	⑬ = 10.57 m ²	⑬ = 58.33 m ²	⑬ = 50.40 m ²	⑬ = 10.57 m ²	⑬ = 6.14 m ²
⑭ = 202.58 m ²	⑭ = 10.57 m ²	⑭ = 10.77 m ²	⑭ = 10.77 m ²	⑭ = 10.77 m ²	⑭ = 6.14 m ²
⑮ = 43.93 m ²	⑮ = 37.00 m ²	⑮ = 37.00 m ²	⑮ = 37.00 m ²	⑮ = 37.00 m ²	⑮ = 6.14 m ²
⑯ = 37.52 m ²	⑯ = 37.00 m ²	⑯ = 37.52 m ²	⑯ = 37.52 m ²	⑯ = 37.52 m ²	⑯ = 6.14 m ²
⑰ = 70.54 m ²	⑰ = 37.52 m ²	⑰ = 37.52 m ²	⑰ = 37.52 m ²	⑰ = 37.52 m ²	⑰ = 6.14 m ²
⑱ = 5.53 m ²	⑱ = 37.52 m ²	⑱ = 37.52 m ²	⑱ = 37.52 m ²	⑱ = 37.52 m ²	⑱ = 6.14 m ²
⑲ = 47.24 m ²	⑲ = 37.52 m ²	⑲ = 37.52 m ²	⑲ = 37.52 m ²	⑲ = 37.52 m ²	⑲ = 6.14 m ²
⑳ = 34.33 m ²	⑳ = 37.52 m ²	⑳ = 37.52 m ²	⑳ = 37.52 m ²	⑳ = 37.52 m ²	⑳ = 6.14 m ²
㉑ = 7.80 m ²	㉑ = 37.52 m ²	㉑ = 37.52 m ²	㉑ = 37.52 m ²	㉑ = 37.52 m ²	㉑ = 6.14 m ²
㉒ = 78.43 m ²	㉒ = 37.52 m ²	㉒ = 37.52 m ²	㉒ = 37.52 m ²	㉒ = 37.52 m ²	㉒ = 6.14 m ²
㉓ = 7.29 m ²	㉓ = 37.52 m ²	㉓ = 37.52 m ²	㉓ = 37.52 m ²	㉓ = 37.52 m ²	㉓ = 6.14 m ²
㉔ = 270.21 m ²	㉔ = 37.52 m ²	㉔ = 37.52 m ²	㉔ = 37.52 m ²	㉔ = 37.52 m ²	㉔ = 6.14 m ²
㉕ = 30.34 m ²	㉕ = 37.52 m ²	㉕ = 37.52 m ²	㉕ = 37.52 m ²	㉕ = 37.52 m ²	㉕ = 6.14 m ²
㉖ = 13.37 m ²	㉖ = 37.52 m ²	㉖ = 37.52 m ²	㉖ = 37.52 m ²	㉖ = 37.52 m ²	㉖ = 6.14 m ²
㉗ = 26.14 m ²	㉗ = 37.52 m ²	㉗ = 37.52 m ²	㉗ = 37.52 m ²	㉗ = 37.52 m ²	㉗ = 6.14 m ²
㉘ = 147.47 m ²	㉘ = 37.52 m ²	㉘ = 37.52 m ²	㉘ = 37.52 m ²	㉘ = 37.52 m ²	㉘ = 6.14 m ²
㉙ = 218.94 m ²	㉙ = 37.52 m ²	㉙ = 37.52 m ²	㉙ = 37.52 m ²	㉙ = 37.52 m ²	㉙ = 6.14 m ²
㉚ = 36.50 m ²	㉚ = 37.52 m ²	㉚ = 37.52 m ²	㉚ = 37.52 m ²	㉚ = 37.52 m ²	㉚ = 6.14 m ²
㉛ = 291.95 m ²	㉛ = 37.52 m ²	㉛ = 37.52 m ²	㉛ = 37.52 m ²	㉛ = 37.52 m ²	㉛ = 6.14 m ²
㉜ = 79.83 m ²	㉜ = 37.52 m ²	㉜ = 37.52 m ²	㉜ = 37.52 m ²	㉜ = 37.52 m ²	㉜ = 6.14 m ²
㉝ = 113.83 m ²	㉝ = 37.52 m ²	㉝ = 37.52 m ²	㉝ = 37.52 m ²	㉝ = 37.52 m ²	㉝ = 6.14 m ²
㉞ = 213.84 m ²	㉞ = 37.52 m ²	㉞ = 37.52 m ²	㉞ = 37.52 m ²	㉞ = 37.52 m ²	㉞ = 6.14 m ²
㉟ = 8.27 m ²	㉟ = 37.52 m ²	㉟ = 37.52 m ²	㉟ = 37.52 m ²	㉟ = 37.52 m ²	㉟ = 6.14 m ²
㊱ = 25.87 m ²	㊱ = 37.52 m ²	㊱ = 37.52 m ²	㊱ = 37.52 m ²	㊱ = 37.52 m ²	㊱ = 6.14 m ²
㊲ = 15.08 m ²	㊲ = 37.52 m ²	㊲ = 37.52 m ²	㊲ = 37.52 m ²	㊲ = 37.52 m ²	㊲ = 6.14 m ²
㊳ = 149.20 m ²	㊳ = 37.52 m ²	㊳ = 37.52 m ²	㊳ = 37.52 m ²	㊳ = 37.52 m ²	㊳ = 6.14 m ²
㊴ = 15.28 m ²	㊴ = 37.52 m ²	㊴ = 37.52 m ²	㊴ = 37.52 m ²	㊴ = 37.52 m ²	㊴ = 6.14 m ²
㊵ = 0.74 m ²	㊵ = 37.52 m ²	㊵ = 37.52 m ²	㊵ = 37.52 m ²	㊵ = 37.52 m ²	㊵ = 6.14 m ²
㊶ = 0.74 m ²	㊶ = 37.52 m ²	㊶ = 37.52 m ²	㊶ = 37.52 m ²	㊶ = 37.52 m ²	㊶ = 6.14 m ²
㊷ = 0.74 m ²	㊷ = 37.52 m ²	㊷ = 37.52 m ²	㊷ = 37.52 m ²	㊷ = 37.52 m ²	㊷ = 6.14 m ²
㊸ = 0.74 m ²	㊸ = 37.52 m ²	㊸ = 37.52 m ²	㊸ = 37.52 m ²	㊸ = 37.52 m ²	㊸ = 6.14 m ²
㊹ = 0.74 m ²	㊹ = 37.52 m ²	㊹ = 37.52 m ²	㊹ = 37.52 m ²	㊹ = 37.52 m ²	㊹ = 6.14 m ²
㊺ = 0.74 m ²	㊺ = 37.52 m ²	㊺ = 37.52 m ²	㊺ = 37.52 m ²	㊺ = 37.52 m ²	㊺ = 6.14 m ²
㊻ = 0.74 m ²	㊻ = 37.52 m ²	㊻ = 37.52 m ²	㊻ = 37.52 m ²	㊻ = 37.52 m ²	㊻ = 6.14 m ²
㊼ = 0.74 m ²	㊼ = 37.52 m ²	㊼ = 37.52 m ²	㊼ = 37.52 m ²	㊼ = 37.52 m ²	㊼ = 6.14 m ²
㊽ = 0.74 m ²	㊽ = 37.52 m ²	㊽ = 37.52 m ²	㊽ = 37.52 m ²	㊽ = 37.52 m ²	㊽ = 6.14 m ²
㊾ = 0.74 m ²	㊾ = 37.52 m ²	㊾ = 37.52 m ²	㊾ = 37.52 m ²	㊾ = 37.52 m ²	㊾ = 6.14 m ²
㊿ = 0.74 m ²	㊿ = 37.52 m ²	㊿ = 37.52 m ²	㊿ = 37.52 m ²	㊿ = 37.52 m ²	㊿ = 6.14 m ²

REVISIONS

HO CHONG TUNG & PARTNERS LIMITED
2/F, 22/F, 23/F, 24/F, 99/F, 100/F


PROJECT:
HONG KONG SCIENCE PARK EXPANSION STAGE 1 (SPX1) AT PAK SHEK KONG, TW HD, T.P.T.L. NO. 204

TITLE:
GREENERY AREA CALCULATION

DATE: 29/01/16	SCALE: 1:500
DRAWN BY: [Name]	CHECKED BY: [Name]
DATE: 29/01/16	SCALE: 1:500
DRAWN BY: [Name]	CHECKED BY: [Name]

31750 B/A10/52b 00

NOTES
 1) THE SITE PLAN, FENCED ENCLOSURE AND TO BE FOLLOWED.
 2) THE LOCATION OF IRRIGATION POINTS, WATER FEATURES, CANOPIES, TENSILE CANOPIES, GRASS PAVEMENT AND OTHER RELATED FEATURES, TO BE ACCORDING TO THE RELEVANT STANDARDS AND SPECIFICATIONS OF THE RELEVANT DEPARTMENT OF THE GOVERNMENT.
 3) LOCATION OF IRRIGATION POINTS AND SHOWN FOR INFORMATION TO BE SUBMITTED SEPARATELY.

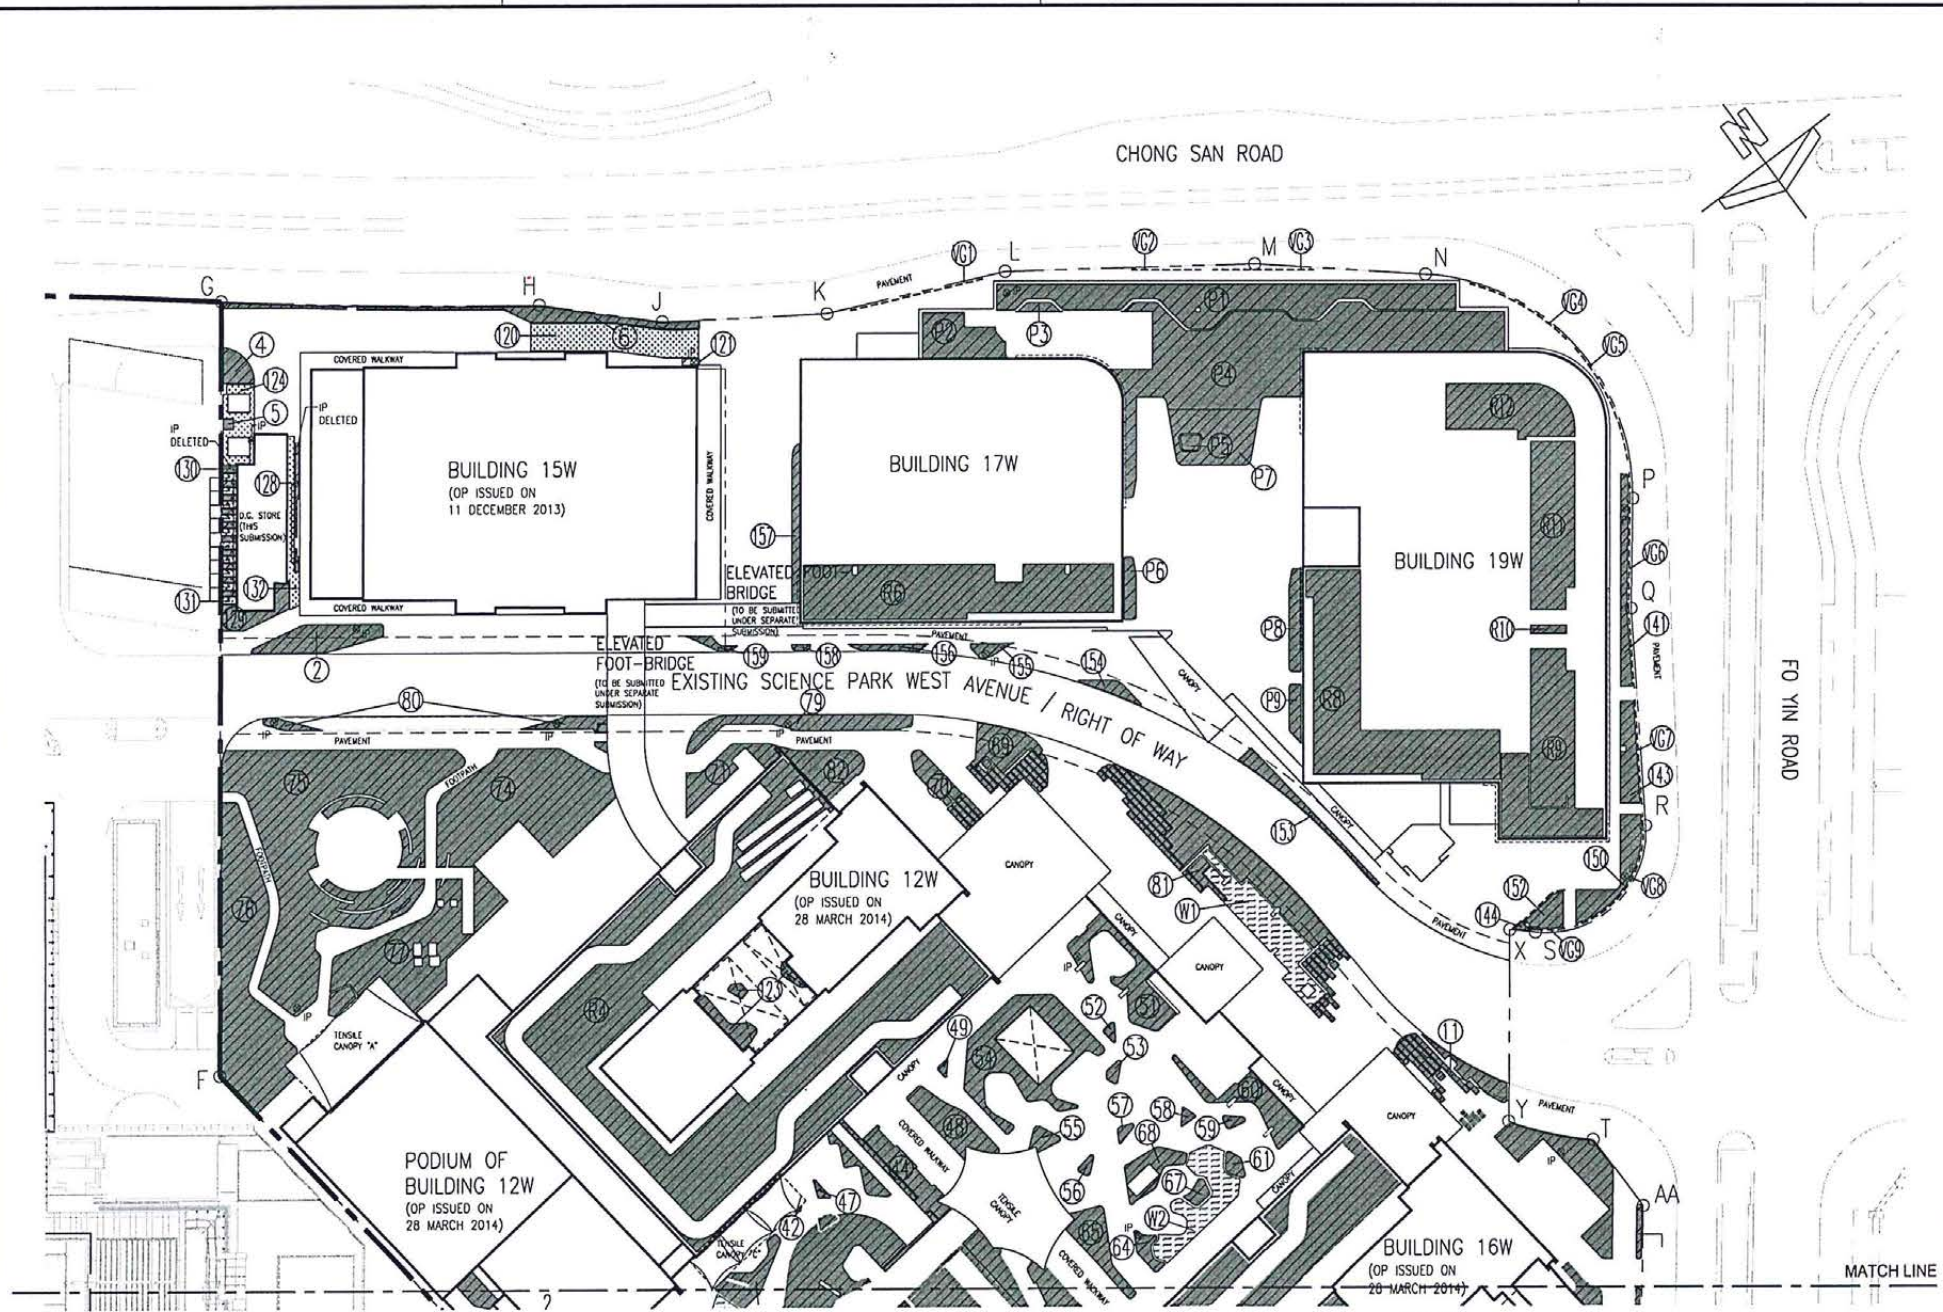

SITE COVERAGE DIAGRAM OF GREENERY
1:300

- LEGEND**
- IRRIGATION POINT
 - UNCOVERED PLANTER AREA
 - WATER FEATURE AREA
 - GRASS PAVEMENT

NO.	REVISIONS



WONG TUNG & PARTNERS LIMITED
 ARCHITECTS & ENGINEERS
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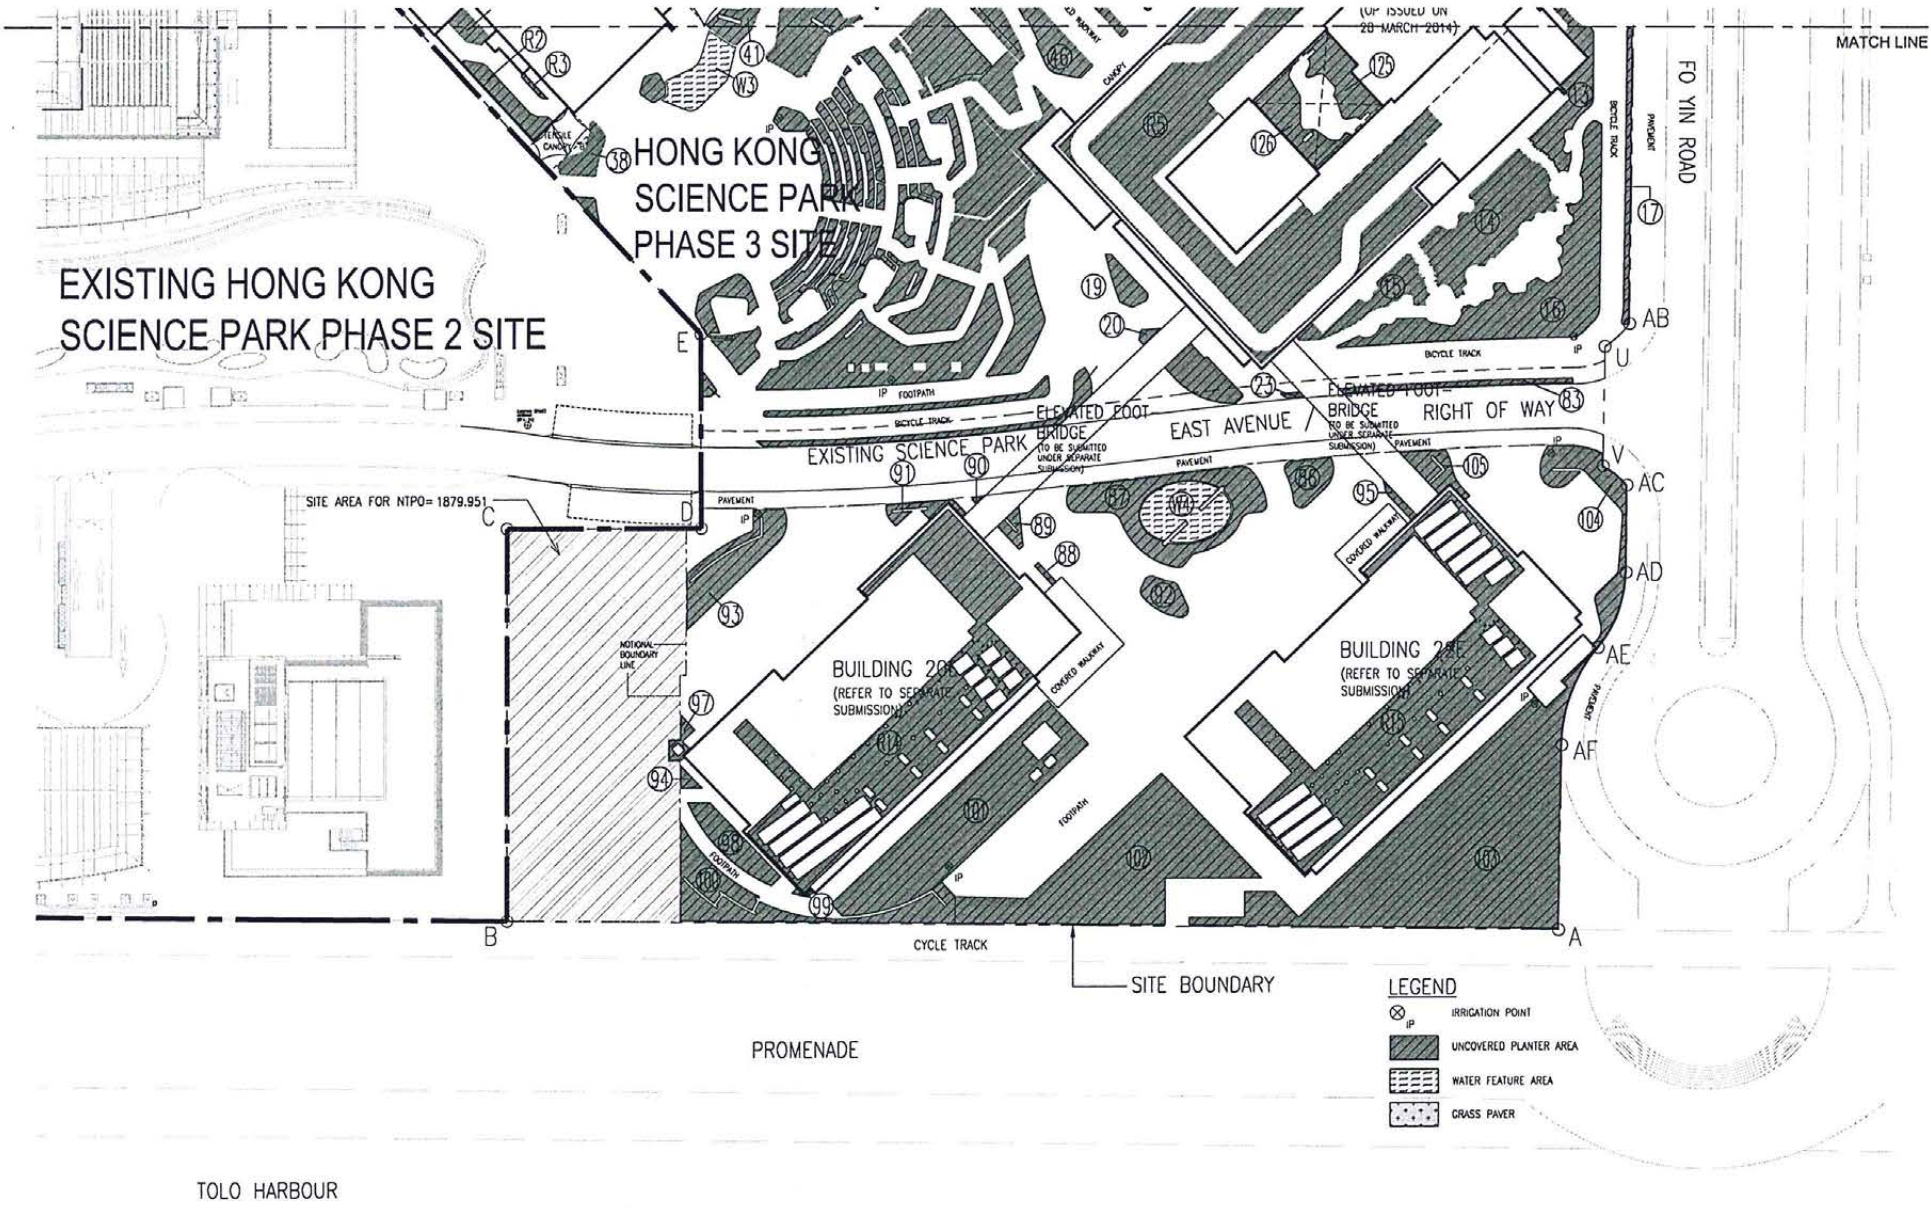
PROJECT:
 HONG KONG SCIENCE PARK
 EXPANSION STAGE 1 (SPX1)
 AT PAK SHEK KONG, TAI HO,
 T.P.T.L. NO. 204

TITLE:
 GREENERY AREA CALCULATION

DATE: 02/09/16	SCALE: 1:300
DRAWN BY: [Name]	CHECKED BY: [Name]
DATE: 02/09/16	SCALE: 1:300
PROJECT NO: 31750 B/A10/52b	00

MATCH LINE

NOTES
 1) THE SCALE SHOWN, PAVED ROADS AND ALL OTHER DETAILS ARE TO BE PROVIDED BY THE CONTRACTOR AND SHALL BE SUBJECT TO THE APPROVAL OF THE PROJECT TEAM. THE CONTRACTOR SHALL BE RESPONSIBLE FOR ANY DISCREPANCY FROM THE INFORMATION PROVIDED BY THE CONTRACTOR.
 2) LOCATION OF IRRIGATION POINTS AND MOUND PROVISION TO BE SUBMITTED SEPARATELY.



EXISTING HONG KONG SCIENCE PARK PHASE 2 SITE

HONG KONG SCIENCE PARK PHASE 3 SITE

EXISTING SCIENCE PARK BRIDGE

EAST AVENUE

FO YIN ROAD

BUILDING 208 (REFER TO SEPARATE SUBMISSION)

BUILDING 209 (REFER TO SEPARATE SUBMISSION)

- LEGEND**
- ⊗ IRRIGATION POINT
 - ▨ UNCOVERED PLANTER AREA
 - ▤ WATER FEATURE AREA
 - ⋯ GRASS PAVER

PROMENADE

TOLO HARBOUR

SITE COVERAGE DIAGRAM OF GREENERY
1:300

NO.	DATE	REVISIONS



WONG TUNG & PARTNERS LIMITED
 ARCHITECTS & PLANNERS
 11/F, 110, Queen's Road East, Victoria Harbour, Hong Kong
 Tel: (852) 2522 8888 Fax: (852) 2522 8889
 PROJECT:
 HONG KONG SCIENCE PARK EXPANSION STAGE 1 (SPK1)
 AT PAK SHEK ROKK, TAI PO, T.P.T.L. NO. 204

TITLE:
GREENERY AREA CALCULATION

DATE	SCALE	NO.
02/2018	1:300	
03/2018		
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BY: [Signature]