METHOD STATEMENT FOR DEMOLITION WORK:

- \1.1 DEMOLITION WORKS SHALL COMPLY WITH BUILDING (DEMOLITION WORKS) REGULATIONS, BS6187:82, CONSTRUCTION SITE (SAFETY) REGULATIONS, THE GUIDELINES AND REQUIREMENTS SET OUT IN PNAP71 AND CODE OF PRACTICE FOR DEMOLITION OF
- ALL STRUCTURES TO BE DEMOLISHED BY ORDINARY HAND-HELD TOOLS. 1.3 \POWERED MECHANICAL PLANTS MAY BE EMPLOYED AND RESTED AT SOLID GROUND TO
- HELP REMOVAL OF DEBRIS AT G/F. 1.4 DEMOLITION SHALL BEGIN ON THE ROOF AND PROCEED DOWN FLOOR BY FLOOR TO THE
- GROUND FLOOR. THE CONCRETE OF EACH STRUCTURAL ELEMENT SHALL BE BROKEN DOWN GRADUALLY. THE REINFORCEMENT SHALL BE LEFT IN PLACE UNTIL THE CONCRETE IS BROKEN AWAY AND WHEN ITS SUPPORT IS NO LONGER NEEDED.
- 1.5 THE DEMOLITION OF EACH STRUCTURAL ELEMENT SHALL BE PERFORMED ACCORDING TO THE DETAILS AS SHOWN ON DEMOLITION PLANS.
- 1.6 BEFORE DEMOLITION WORKS, THE PROPPING UNDERNEATH CANTILEVER BEAMS IF ANY
- 1.7 BEFORE DEMOLITION WORKS, ALL UNAUTHORIZED STRUCTURES SHALL BE REMOVED. 1.8 THE CONTRACTOR SHOULD VERIFY THE STRUCTURE WITH THE LATEST STRUCTURE
- APPROVED PLANS (INCLUDING A&A WORKS) BEFORE COMMENCEMENT OF THE DEMOLITION WORKS. WHERE CONDITIONS ON SITE REVEALED SITUATION AND ARRANGEMENT DIFFERENT FROM THE AVAILABLE INFORMATION, OR HAVING ANY POTENTIAL INSTABILITY, THE CONTRACTORS SHOULD SEEK OPINION AND ADVICE FROM AP/RSE BEFORE PROCEED.
- 1.9 GROUND FLOOR SLAB TO BEFOR REFERENCE ONLY
- 1.10 ALL SCAFFOLDING WORKS SHOULD STRICTLY FOLLOW THE GUIDANCE NOTES OF CODE OF PRACTICE FOR BAMBOO SCAFFOLDING SAFETY AND GUIDANCE NOTES TO RENOVATION SAFETY ISSUED BY LABOUR DEPARTMENT.
- 2. DEMOLITION SEQUENCE (TOP DOWN BY MANUAL METHOD)
- 2.1 DEMOLITION SEQUENCE SHALL BE DETERMINED ACCORDING TO THE ACTUAL SITE CONDITIONS, RESTRAINTS, ORIGINAL BUILDING LAYOUT AND ITS CONSTRUCTION. IN GENERAL, THE FOLLOWING SEQUENCE SHALL APPLY:
 - (i) ALL CANTILEVERED STRUCTURE CANOPIES, AND VERANDAHS SHALL FIRST BE DEMOLISHED PRIOR TO THE DEMOLITION OF MAIN BUILDING AND ITS INTERNAL
 - STRUCTURES ON EACH FLOOR; (ii) THE STRUCTURAL ELEMENTS, IN GENERAL, SHALL BE DEMOLISHED IN THE
 - FOLLOWING SEQUENCE:
 - SECONDARY BEAMS, THEN
 - INTERNAL PRIMARY BEAMS
 - (iii) ALL DEMOLITION WORKS TO BE CARRIED OUT FLOOR BY FLOOR.
 - (iv) THE PERIPHERAL ELEMENT OF THE BUILDING SHALL BE DEMOLISHED IN ACCORDANCE WITH THE DEMOLITION SEQUENCE OF PERIPHERAL ELEMENTS.
 - (v) THE INTERNAL ELEMENT, INCLUDING BEAMS AND COLUMNS SHALL BE DEMOLISHED BY GRADUALLY BREAKING DOWN THE CONCRETE OR BY PULLING THEM DOWN IN A
 - (vi) THE ABOVE PROCEDURES SHALL BE REPEATED (IF NECESSARY) FOR DEMOLITION DOWN TO THE LOWEST FLOOR AT GROUND LEVEL.
- 3. PRIOR TO COMMENCEMENT OF THE DEMOLITION WORK AN ASBESTOS INVESTIGATION SURVEY SHALL BE CARRIED OUT BY A SPECIALIST ASBESTOS CONSULTANT FIRM TO DETERMINE ANY ASBESTOS BASED PRODUCTS WHICH MAY EXIST.

DEMOLITION SEQUENCE:

- REMOVE THE UBW WORKS UNDER MINOR WORKS IF APPLICABLE.
- PRIOR TO THE DEMOLITION WORKS, THE HOARDING SHALL BE CONSTRUCTED IN
- ACCORDANCE WITH THE HOARDING PLANS UNDER SEPARATE SUBMISSION. THE TWO-STORIES PROPPING SHOULD BE PROVIDED PRIOR TO START OF DEMOLITION WORK.
- REMOVE ALL UBW STRUCTURES. DEMOLITION SEQUENCE OF ROOF FLOOR:
- a. PARAPETS, STAIRHOOD AND OTHER STRUCTURES ABOVE ROOF FLOOR LEVEL;
- b. EXTERIOR WALLS LINKING THE CANTILEVERED STRUCTURE AT ROOF FLOOR; c. CANTILEVER SLABS OR CANOPY AT ROOF FLOOR;
- d. REMAINING SLAB AT ROOF FLOOR;
- e. NON-LOAD BEARING W FOR REFERENCE ONLY LOOR BELOW ROOF FLOOR; SECONDARY BEAMS AT ROUF FLOOR,
- . MAIN BEAMS AT ROOF FLOOR;
- . COLUMNS AND LOAD BEARING WALLS BETWEEN ROOF AND FLOOR BELOW ROOF.
- DEMOLITION OF SUBSEQUENT FLOORS BELOW ROOF FLOOR:
- a. PARAPETS, STAIRHOOD AND OTHER STRUCTURES ABOVE FLOOR LEVEL IF APPLICABLE; b. EXTERIOR WALLS LINKING THE CANTILEVERED STRUCTURES IF APRLICABLE;
- c. CANTILEVERED SLABS OR CANOPY; d. REMAINING SLABS;
- e. NON-LOAD BEARING WALLS BETWEEN THE FLOOR AND THE FLOOR BELOWS.
- f. SECONDARY BEAMS; a. MAIN BEAMS;
- h. COLUMNS AND LOAD BEARING WALLS BETWEEN THE FLOOR AND THE FLOOR BELOW.

DEMOLITION OF CANTILEVER STRUCTURE:

- T. PROPPINGS SHALL BE INSTALLED FOR ALL CANTILEVERED STRUCTURES PRIOR TO COMMENCEMENT OF DEMOLITION WORKS.
- NO STRUCTURAL MEMBERFOR REFERENCE ONLY BOVE THAT FLOOR CAN BE DEMOLISHED PRIOR TO THE DEMOLITICIN OF THE CANTILLEVER STRUCTURE AT THAT FLOOR.
- THE EXTERIOR WALL CONNECTED SHALL BE DEMOLISHED FIRST WITH THE CANTILEVER SLAB.
- ANY STRUCTURE OR DEAD LOAD SUPPORTED BY THE CANTILEVERED SYSTEM SHALL BE REMOVED PRIOR TO DEMOLISHING THE CANTILEVER SLAB.
- THE CONCRETE SHALL BE BROKEN DOWN GRADUALLY STARTING FROM THE EXTERIOR EDGE OF THE CANTILEVER FLOOR, WORKING INWARD AND TOWARD ITS SUPPORTING BEAMS.

DEMOLITION OF BRICK IN-FILL WALL:

TO AVOID ANY POTENTIAL HAZARD OF BRICKS FALLING OUT OF THE BUILDING, ALL THE BRICK IN-FILL SHALL BE REMOVED BY PUSHING INWARD, BEFORE DISMANTLING THE REINFORCED CONCRETE FRAMING. WORKING PLATFORMS OUTSIDE TFOR REFERENCE ONLY) FOR REMOVAL OF THE BRICK IN-FILL WALLS. BRICK REMOVAL SHALL BEGIN FROM LITE FOR LATER DOWNWARDS. THE WORKS SHALL BE CARRIED OUT LAYER BY LAYER WITH EACH LAYER NOT LARGER THAN 300mm.

PRECAUTIONARY MEASURES:

- HOARDING (SUBMITTED SEPARATELY)
 - THE HOARDING SHALL BE CONSTRUCTED IN ACCORDANCE WITH THE HOARDING PLANS UNDER SEPARATE SUBMISSION.
- TEMPORARY SUPPORT
- STEEL PROPPING SHALL HAVE A WORKING CAPACITY OF 25kN PER PROP. THE PROPS SHALL BE BRACED WITH LATERAL RESTRAINTS IN AT LEAST TWO DIRECTIONS.
- EXISTING UTILITIES ALL EXISTING UTILITIES SHALL BE TERMINATED. SEWER SERVICE AND DRAINAGE CONNECTIONS SHALL BE PROPERLY DISCONNECTED AND SEALED OFF AT LAST MANHOLE. CONTRACTOR SHALL ASSIST THE CLIENT TO COORDINATE WITH UTILITY COMPANIES FOR ALL SERVICE TERMINATION.
- NOTIFICATION TO AP/RSE FOR ANOMALIES OR IRREGULARITIES OBSERVED THE FRAMING PLANS ARE RECORDED ON SITE. PRIOR TO THE DEMOLITION WORK, THE CONTRACTOR SHOULD CARRY OUT A DETAILED INSPECTION TO VERIFY THE ACCURACY OF THE INFORMATION AS SHOWN. WHERE CONDITIONS ON SITE REVEALED SITUATION AND ARRANGEMENT DIFFERENT FROM NORMAL OR HAVING ANY POTENTIAL HAZARDS. THE
- CONTRACTOR SHOULD SEEK OPINION AND ADVICE OF AP/RSE BEFORE PROCEEDING THE CONTRACTOR SHOULD EXAMINE AND IDENTIFY FOR THEMSELVES OF THE NATURE OR TAIL-LOADING OF ANY CANTILEVER CONSTRUCTION SUCH AS BALCONIES, HEAVY CORNICES OR STAIRCASES. IF UNCERTAIN, AP/RSE ADVICE SHOULD BE SOUGHT. GENERALLY, ALL
- CANTILEVER CONSTRUCTION SHOULD BE PROPPED PRIOR TO THE ACTUAL DEMOLITION. 4.3 THE CONTRACTOR SHOULD NOTIFY THE AP/RSE DURING THE COURSE OF DEMOLITION WORKS, THE FOLLOWING DEFECTS, IF ANY
 - (i) STRUCTURAL DEFORMATION: (ii) CRACK: AND
 - (iii) CORROSION OF REINFORCEMENT
- - 5.1 ANY EXISTING FURNITURE, WOOD FLOORS, DOOR FRAMES, WINDOWS, PIPING SHALL BE SORTED AND REMOVED SEPARATELY.
 - DEMOLITION DEBRIS SHALL BE PICKED UP ON GROUND FLOOR AND CARRIED AWAY BY DUMP TRUCKS. DEBRIS &LEARING AND TRANSPORTATION SHALL BE SCHEDULED TO MAINTAIN THE FOLLOWING CONDITIONS:
 - (i) DEBRIS ACCUMULATION ON THE COCKLOFT OR FIRST FLOOR OR ABOVE SHALL
 - NOT BE HIGHER THAN 100mm. (ii) DEBRIS ACCUMULATION ON THE GROUND FLOOR SHALL NOT EXCEED 1m. (iii) NO DEBRIS SHALL BE ALLOWED TO ACCUMULATE ON THE CANTILEVER
- STRUCTURES. 6. SPECIAL SITE SAFETY

FOLLOWING:

FOR REFERENCE ONLY

- 6.1 EMERGENCY EXIT THE EXISTING STAIRCASE SHALL BE USED AS EMERGENCY ROUTE. THE EMERGENCY ROUTE SHALL BE MAINTAINED THROUGHOUT THE DEMOLITION PROCESS. THE ROUTE SHALL BE CLEARED OF OBSTRUCTION AT ALL TIME. SIGNS OR MARKINGS SHALL BE INSTALLED TO
- 6.2 PROTECTION OF OPENINGS THE CONTRACTOR SHOULD ENSURE THAT EVERY WORK PLACE AND APPROACH AND ALL OPENINGS DANGEROUS TO PERSONS EMPLOYED AND OTHERS BE PROPERLY ILLUMINATED AND PROTECTED. SATISFACTORY MEASURES SHALL BE PROVIDED TO AVOID PERSONS FALLING FROM HEIGHT.
- 6.3 FIRE PREVENTION (i) FIRE EXTINGUISHER OR FIRE FIGHTING EQUIPMENT SHALL BE PLACED IN VISIBLE LOCATIONS, ADJACENT TO THE STAIRCASE, ON EACH FLOOR, ALL\FLAMMABLE MATERIALS SHALL BE STORED IN A SAFE LOCATION IN ACCORDANCE WITH THE
- FACTORIES AND INDUSTRIAL UNDERTAKING REGULATIONS. 6.4 DUST AND NOISE (i) WATER SPRAYING SHALL BE APPLIED TO SUPPRESS THE DUST GENERATED DURING
 - THE DEMOLITION OPERATION AND DEBRIS HAULING. (ii) SUPER SILENCED TYPE AIR COMPRESSOR SHALL BE USED. DEMOLITION WORKS SHALL NOT BE PERFORMED WITHIN THE RESTRICTED HOURS FROM 1900 HRS TO 0700 HRS ON ALL DAY AND FROM 0700 HRS TO 1900 HRS ON GENERAL HOLIDAYS INCLUDING SUNDAY. OR AS PER EPD'S REQUIREMENT.
- TRAINING ALL SITE PERSONNEL SHALL GO THROUGH A TRAINING PROGRAM TO UNDERSTAND THE PROJECT AND SITE SAFETY REQUIREMENTS. THE TRAINING PROGRAM SHALL BE CONDUCTED BY A COMPETENT TRAINER. THE TRAINING PROGRAM SHALL INCLUDE THE
- (i) AN INDUCTION TRAINING COURSE AT THE BEGINNING OF THE JOB TO CIRCULATE INFORMATION ON THE PROPOSED METHOD AND REQUIRED SAFETY MEASURES TO PERFORM THE WORK.
- (ii) DAILY SAFETY MEETINGS TO MAINTAIN AND REINFORCE THE SAFETY CONCEPT. TYPHOON
- IN THE CASE WHEN TYPHOON SIGNAL NO. 3 IS HOISTED, THE CONTRACTOR SHALL INSPECT ALL EXTERNALLY EXPOSED TEMPORARY WORK AND STRENGTHEN ANY LOOSE CONNECTIONS. AFTER THE TYPHOON, ALL EXTERNALLY EXPOSED TEMPORARY WORKS SHALL BE INSPECTED AND CONFIRMED TO BE SAFE BY THE COMPETENT AND EXPERIENCE

MAINTENANCE AND INSPECTION

- THE DEMOLITION WORKS SHALL BE SUPERVISED BY AUTHORIZED PERSON. REGISTERED STRUCTURAL ENGINEER, REGISTERED SPECIALIST CONTRACTOR AND THEIR TECHNICALLY COMPETENT PERSON IN ACCORDANCE WITH THE SITE SAFETY SUPERVISION PLAN LODGED WITH BUILDING AUTHORITY.
- ALL THE PRECAUTIONARY MEASURES AND TEMPORARY SUPPORTS SHALL BE INSPECTED BY THE CONTRACTOR ON A DAILY BASIS. ANY ACCUMULATION OF BUILDING DEBRIS ON THE CATCH FANS AND CATCH PLATFORMS SHALL BE REMOVED. ANY DEFICIENCY SHALL BE REPAIRED WHEN FOUND NECESSARY. THE INSPECTION AND REPAIR RECORDS SHALL BE
- PROVIDED TO THE AP AND RSE. 7.3 BEFORE LEAVING THE JOB SITE EACH DAY, THE CONTRACTOR SHALL IDENTIFY AND RECTIFY ANY UNSAFE CONDITIONS SUCH AS PARTIALLY DEMOLISHED STRUCTURAL ELEMENTS AND DAMAGED TEMPORARY SUPPORTS.
- 7.4 THE BAMBOO SCAFFOLDING SHALL BE INSPECTED AND MAINTAINED IN ACCORDANCE WITH WITH THE CODE OF PRACTICE FOR BAMBOO SAFETY AND THE CONSTRUCTION SITE (SAFETY) REGULATIONS BY THE CONTRACTOR.
- 8.1 EMERGENCY TELEPHONE NUMBERS SHALL BE CLEARLY DISPLAYED IN A CONSPICUOUS LOCATION. IN THE EVEN OF ANY EMERGENCY OR ACCIDENT, THE CONTRACTOR SHALL
- CONTRACTOR SHALL ALSO NOTIFY THE AP AND RSE IMMEDIATELY. 8.2 AT THE INITIAL WARNING OF A TYPHOON OR A MAJOR STORM EVENT, THE FOLLOWING SHALL

NOTIFY THE POLICE AND FIRE SERVICES DEPARTMENTS FOR ASSISTANCE. THE

- 8.2.1 CONTRACTOR SHALL SECUFOR REFERENCE ONLYRTS AND LOOSE
- ELEMENTS ON SITE. 8.2.2 ALL FLAMMABLE MATERIALS, OXYGEN AND ACETYLENE BOTTLES SHALL BE
- REMOVED OR SECURED IN A SAFE LOCATION. 8.2.3 NO UNSTABLE AND/OR PARTIALLY DEMOLISHED STRUCTURAL ELEMENTS SHALL BE BRACED AND SECURED.
- POST DEMOLITION
- 9.1 UPON COMPLETION OF THE DEMOLITION, THE SITE SHALL BE LEVELLED AND CLEARED OF
- 9.2 IN THE CASE OF NO IMMEDIATE REDEVELOPMENT, THE SITE BOUNDARY SNALL BE COMPLETELY ENCLOSED TO PREVENT PUBLIC ACCESS.
- 9.3 DAMAGE TO PAVEMENT, FOOTPATH AND OTHER ELEMENTS WITHIN THE RIGHT OF WAY SHALL BE REPAIRED TO ITS ORIGINAL CONDITION PRIOR TO THE COMPLETION OF THE
- SITE SUPERVISION 10.1 SITE STAFF RESPONSIBLE FOR SUPERVISION AND CONTROL OF DEMOLATION SHALL BE EXPERIENCED IN THE DEMOLITION OF BUILDINGS SIMILAR TO THOSE TO BE DEMOLISHED. THE CONTRACTOR SHALL PROVIDE THE FOLLOWING MINIMUM SITE SUPERVISION
 - REQUIREMENTS: (i) A FULL-TIME SITE ENGINEER WHO SHALL BE REGISTERED PROFESSIONAL ENGINEER, IN THE STRUCTURAL, CIVIL OR BUILDING DISCIPLINE AND SHALL BE DIRECTLY RESPONSIBLE TO THE CONTRACTOR DURING DEMOLITION OF CANTILEVER STRUCTURES.
 - (ii) EXPERIENCED FOREMAN WHO SHALL BE FULL-TIME ON SITE. EACH FOREMAN SHALL BE RESPONSIBLE AND SUPERVISE THE DEMOLITION WORKS FOR EACH ZONE OF THE DEMOLITION WORKS.
 - (iii) SITE SUPERVISION REQUIREMENTS AS STIPULATED IN THE LATEST VERSION OF THE DEMOLITION CODE AND BUILDING (DEMOLITION WORKS) REGULATION.

NOTES ON UBW:

1. UBW SHALL BE REMOVED UNDER FOR REFERENCE ONLY STEM OR UNDER AP/RSE SUPERVISION UPON ISSUANCE OF THE DEWICETION CONSENT AS INDICATED ON PLANS.

NOTES ON DEBRIS MANAGEMENT SYSTEM:

- 1. DEBRIS MUST BE DISPOSED OF PROMPTLY. A DEBRIS DISPOSAL AND MANAGEMENT SYSTEM SHALL BE PREPARED AND IMPLEMENTED BY THE RSC TO THE SATISFACTION OF AP / RSE. THE DEBRIS DISPOSAL AND MANAGEMENT SYSTEM SHOULD LAY DOWN THE FOLLOWING DETAILS:
- 1.2 THE ROUTING AND MOVEMENT OF DEBRIS FROM EACH FLOOR TO ON GRADE HOLDING AREA PRIOR TO LEAVING THE SITE:
 - 1.3 MEANS OF TRANSPORTATION OF DEBRIS OFF THE SITE; 1.4 TIME AND FREQUENCY OFOR REFERENCE ONLYES

1.1 METHOD OF HANDLING DEMOLISHED BUILDING DEBRIS;

- 1.5 RECORD SCHEME ON THE TONNAGE OF EACH TRUCK LOAD, TRUCK LICENSE PLATE, DRIVER'S NAME, TRIP TICKETS AND LOCATION OF DUMP SITE; AND
- 1.6 THE SITE SUPERVISORY PERSONNEL RESPONSIBLE FOR THE DEBRIS MANAGEMENT
- DETAILS OF THE DEBRIS DISPOSAL AND MANAGEMENT SYSTEM SHALL BE SUBMITTED TO THE BUILDINGS DEPARTMENT TOGETHER WITH THE SITE SAFETY SUPERVISION PLAN PRIOR TO OR AT THE TIME OF CONSENT APPLICATION.

NOTES ON SITE VIDEO CAMERA:

1. VIDEO CAMERA TO RECORD THE ENTIRE DEMOLITION PROCESS SHALL BE PROVIDED. THE VIDEO CAMERA SHALL BE SECURELY PROTECTED FROM BEING TEMPERED WITH SO THAT THE ENTIRE DEMOLITION PROCESS INCLUDING THE MOVEMENT OF DEPDIS AND THE OVERALL SEQUENCE OF DEMOLITION CAN BE RECORDED FOR REFERENCE ONLY W PURPOSES. THE LOCATION OF THE VIDEO CAMERA REFERS TO DEMOLITION PLAN. THE VIDEO CAMERA RECORDS SHALL BE KEPT BY THE RSE FOR AT LEAST 14 DAYS.

NOTES ON BEAM PLUS:

N 819792760.292

E 835350861.425

SITE

N 819700185.607 E 835353432.766

K.I.L 201

STRE

12200

MMM SIREET

N 819703101.028 E 835368365.835

N 819789844.87


E 835335928.356

NO.978

NO.976

NO.974

1. DEMOLITION WORKS AND RELEVIFOR REFERENCE ONLYDURES WILL COMPLY WITH THE BUILDING ENVIRONMENTAL ASSESSMENT METHOD (BEAM) PLUS V1.2 REQUIREMENT.

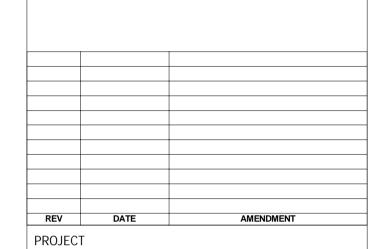

BD REF

BIM REF

GENERAL NOTES FOR DEMOLITION

CIC SAMPLE PROJECT

SCALE	
DRAWING NO.	REV. NO.
D001	

90mm (W) x 40mm (H) space

for COMPANY LOGO

90mm (W) x 60mm (H) space

signature/ and stamp chop


for AP/RSE/RGE's

BD's OFFICAL USE


SOURCE ---

90mm (W) x 150mm (H) space for BD's approval stamp / certification of copies of approved plans (PNAP ADM-10 APP A)

BLOCK PLAN

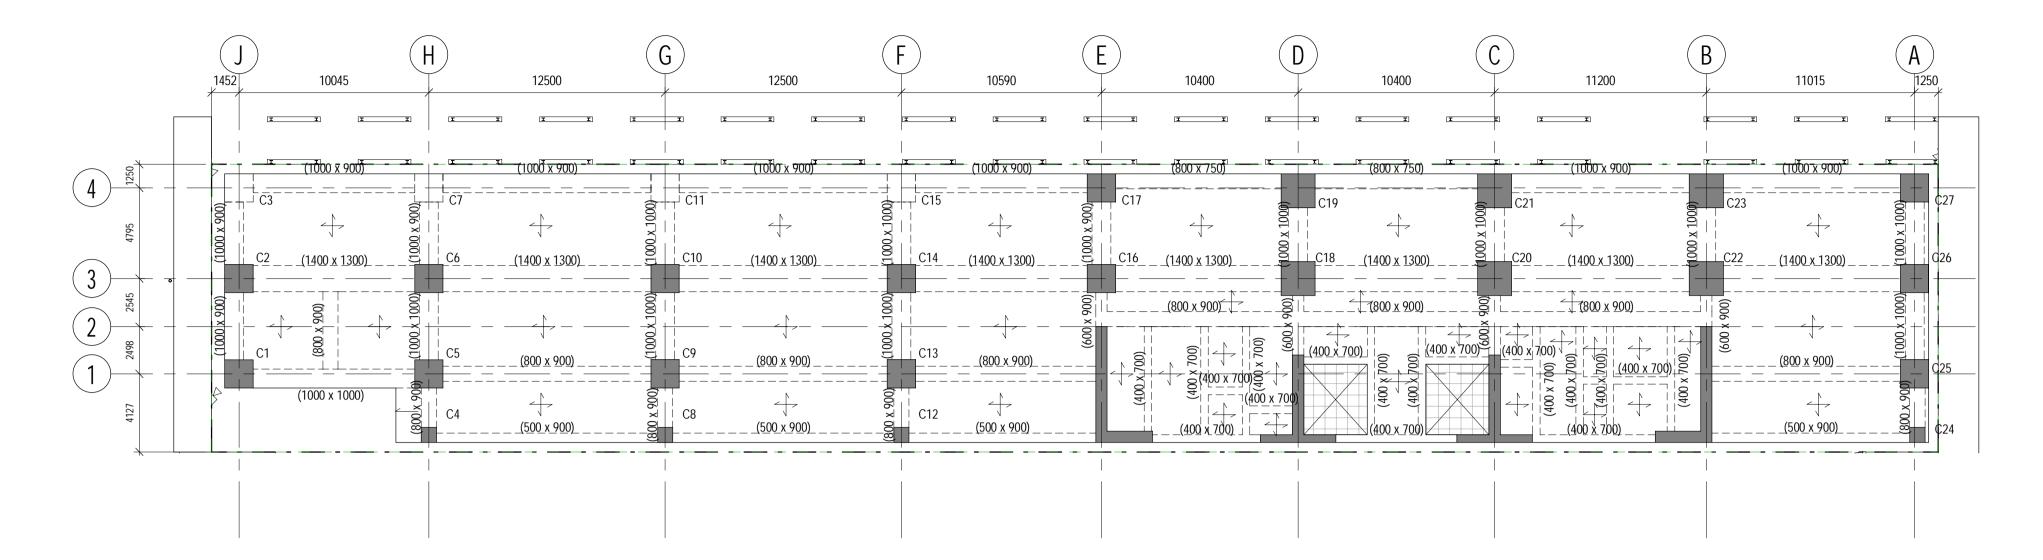

1 DEMOLITION PLAN - EXISTING G/F FRAMING PLAN 1: 200

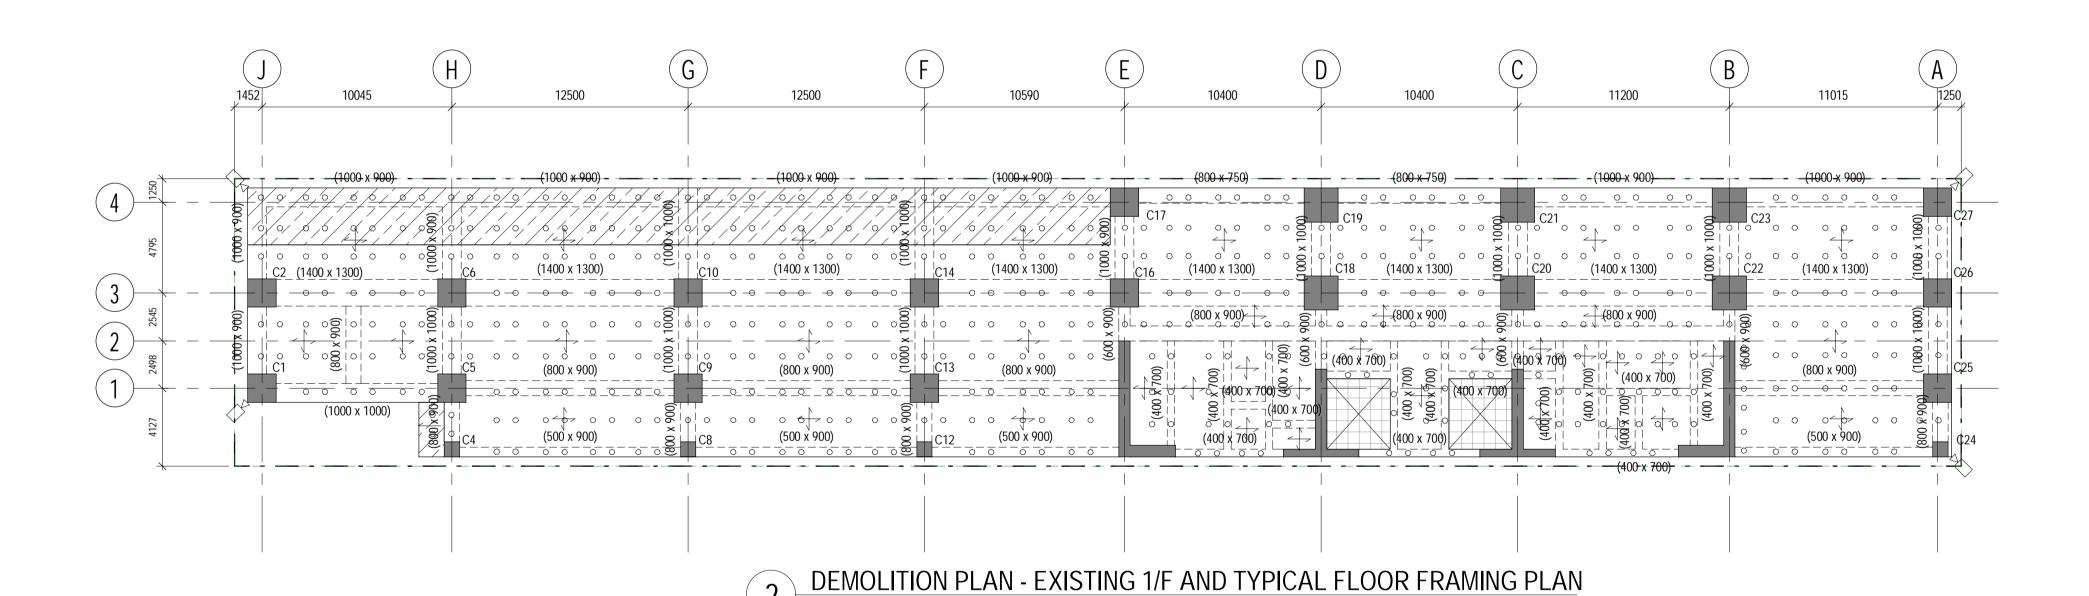

LEGEND:


TEMPORARY STEEL PROP AT 1200mm c/c UNDER
PROPOSED DEBRIS CHUTE

CANTILEVER STRUCTURE

SITE BOUNDARY

CONCRETE FOOTING

VIDEO CAMERA

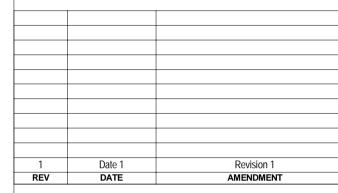

PROJECT
CIC SAMPLE PROJECT

BD REF

BIM REF

DRAWING TITLE
DEMOLITION PLAN - EXISTING G/F, 1/F
FRAMING PLAN

DRAWING NO. REV. NO. D002

SOURCE ---

90mm (W) x 40mm (H) space for COMPANY LOGO


90mm (W) x 60mm (H) space for AP/RSE/RGE's signature/ and stamp chop

BD's OFFICAL USE


90mm (W) x 150mm (H) space for BD's approval stamp / certification of copies of approved plans (PNAP ADM-10 APP A)

TYPICAL SEQUENCE OF TOP DOWN METHOD WITH HAND HELD TOOLS SCREEN SCAFFOLDING CATCHFAN AT INTERVALS NO MORE THAN 10m


1. DEMOLITION OF SLABS AND BEAMS.

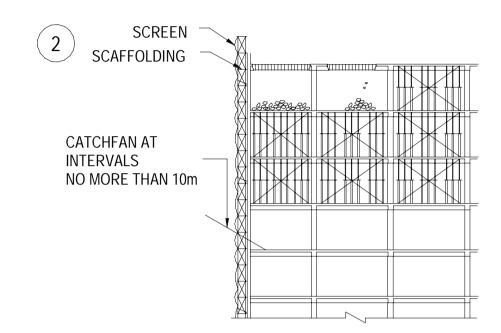


2. CONTINUE DEMOLITION OF SLABS AND BEAMS.

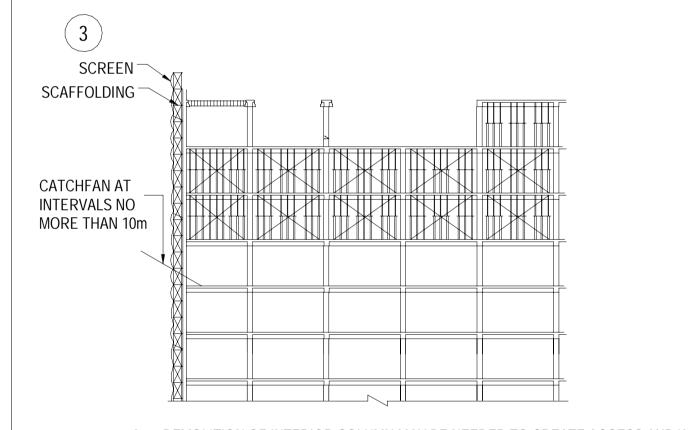

3. DEMOLITION OF INTERIOR COLUMN MAY BE NEEDED TO CREATE ACCESS AND WORKING ROOM FOR EXTERIOR WALL DEMOLITION. DEMOLISH COLUMN BY FIRST PRE-WEAKENING THE BOTTOM. THEN THE FRAME SHALL BE PULLED DOWN AND CONTROLLED MOTION IMMEDIATELY AFTER THE REINFORCING STEEL IS CUT AT THE DISCONNECTING POSITIONS.

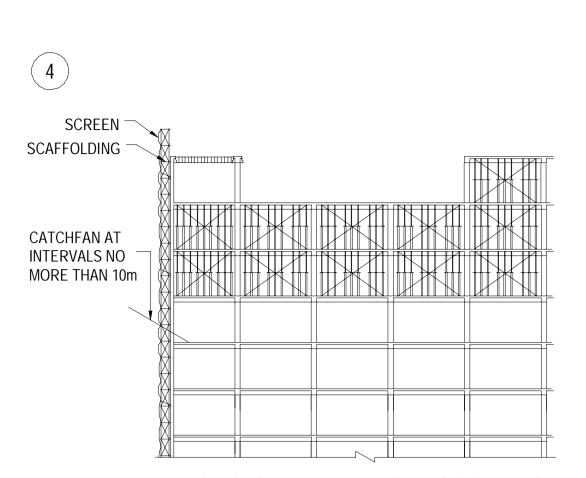


- 4. DEMOLITION OF EXTERNAL WALL CUTTING SHOULD BE CAREFUL TO MINIMIZE DEBRIS FALLING OUTSIDE.
- 5. CUTTING THE EXTERIOR WALL IN SECTIONS AND COLUMNS. CUTTING SHOULD BE CAREFUL TO MINIMIZE DEBRIS FALLING OUTSIDE.

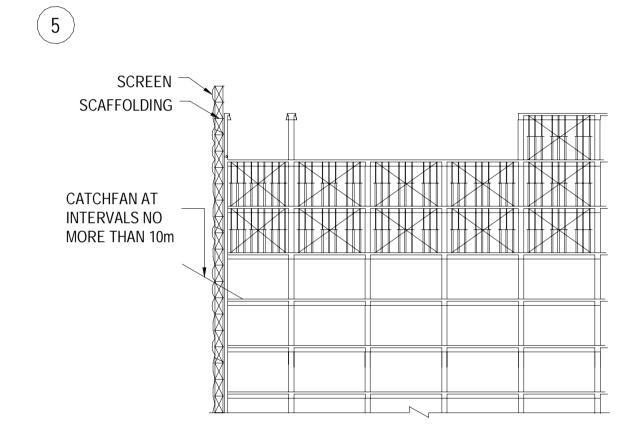

- 6. WHILE CUTTING THE REINFORCEMENT BARS CONNECTING THE WALL SECTION. THE WALL SHOULD BE TIED TO INTERIOR COLUMN OR BEAM. THE WALL SECTION / COLUMN SHALL BE PULLED DOWN IN A CONTROLLED MOTION.
- 7. DEMOLITION OF SLABS AND BEAMS OF THE REMAINING BLOCK.
- 8. DEMOLISH COLUMN AND WALLS OF THE REMAINING BLOCK.

PROJEC	DATE T SAMPLE PRO	DJECT
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PROJECT CIC S	SAMPLE PRO	DJECT
PROJECT CIC S DRAWING DEMO	SAMPLE PRO	DJECT TAILS (BY HAND HELD
DRAWING DEMO	G TITLE DLITION DE	DJECT
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DRAWING TOOL SCALE DRAWING DOOG	G TITLE DLITION DET LS) G NO. 90mm (V	DJECT TAILS (BY HAND HELD
DRAWING TOOL SCALE DRAWING DOOG	G TITLE DLITION DET LS) G NO. 90mm (V	TAILS (BY HAND HELD REV. NO.
DRAWING TOOL SCALE DRAWING DOOG	G TITLE DLITION DE S) G NO. 90mm (V for COMI	TAILS (BY HAND HELD REV. NO. V) x 40mm (H) space PANY LOGO V) x 60mm (H) space
DRAWING TOOL SCALE DRAWING DOOG	G TITLE DLITION DET S) G NO. 90mm (V for COMI	TAILS (BY HAND HELD REV. NO. V) x 40mm (H) space PANY LOGO
DRAWING DEMOTOOL SCALE DRAWING DOOS SOURCE	G TITLE DLITION DET S) G NO. 90mm (V for COMI	TAILS (BY HAND HELD REV. NO. V) x 40mm (H) space PANY LOGO V) x 60mm (H) space SE/RGE's


90mm (W) x 150mm (H) space for BD's approval stamp / certification of copies of approved plans (PNAP ADM-10 APP A)

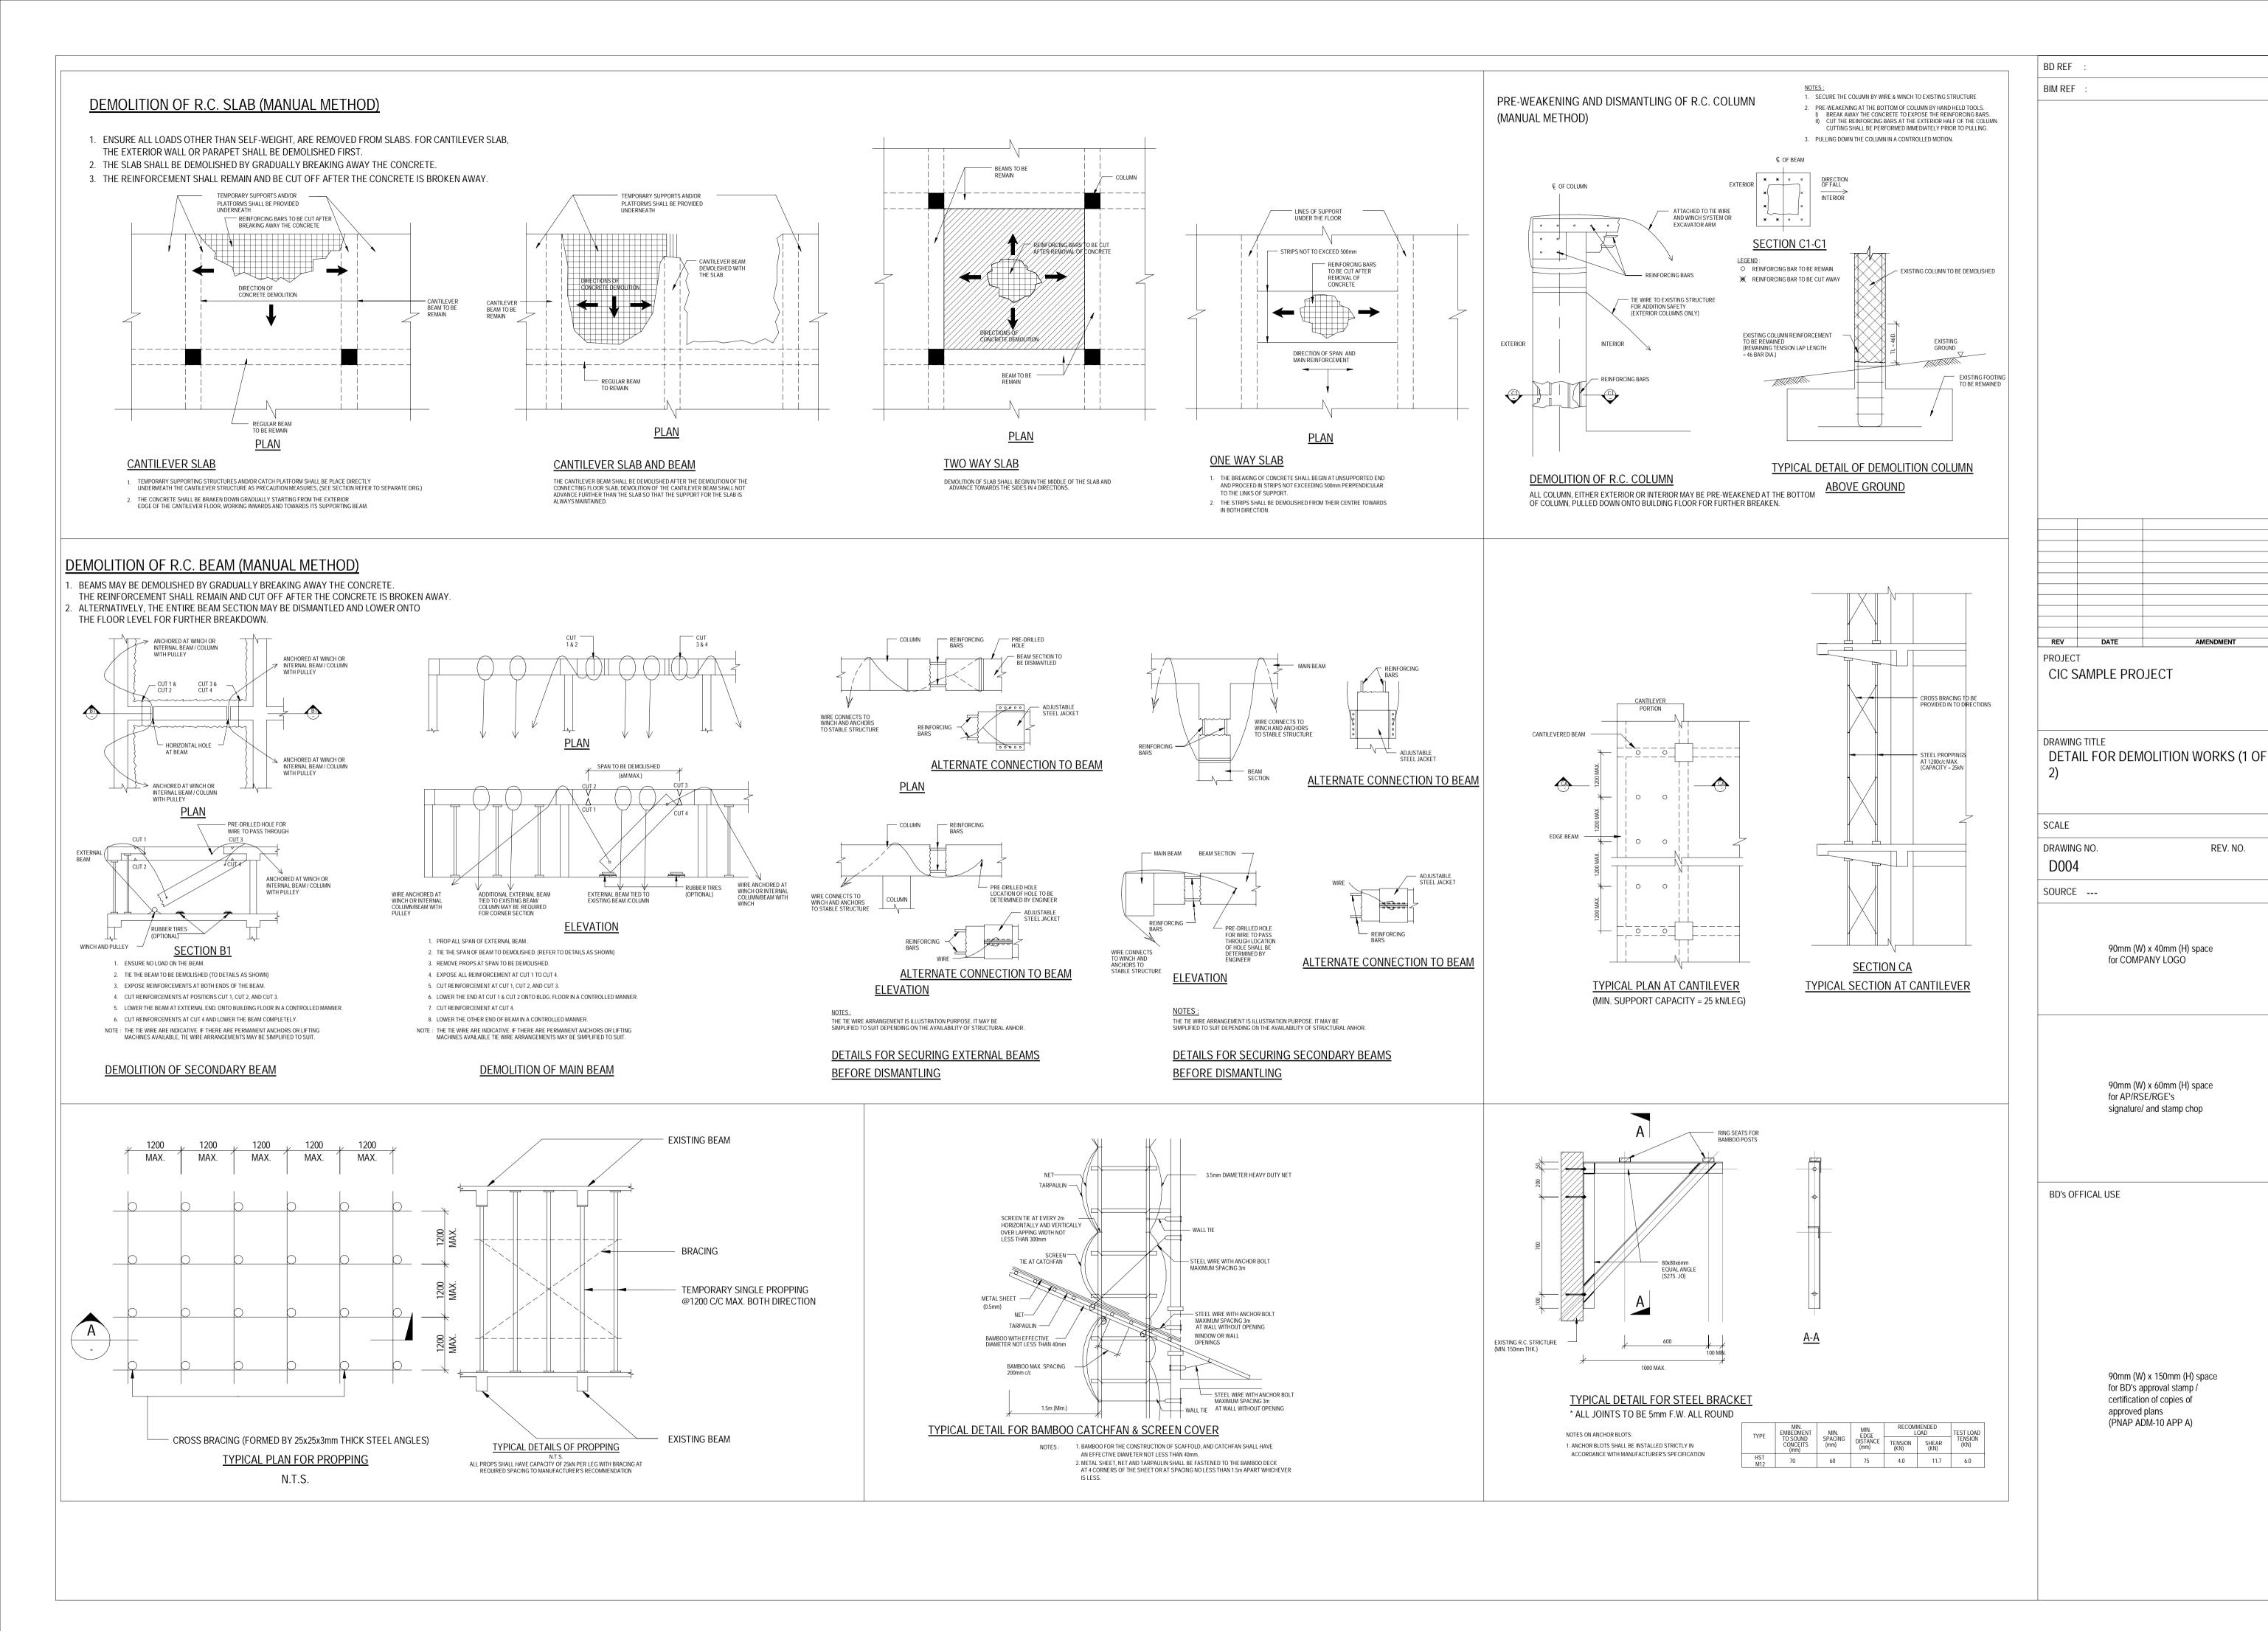


FELLING OF R.C. WALL (MANUAL METHOD) 1. REINFORCEMENT CONCRETE WALLS MAY BE DEMOLISHED BY CUTTING DOWN THE WALL INTO MANAGEABLE SECTIONS, PRE-WEAKED AT THE WALL BASE AND PULLED DOWN ONTO BUILDING FLOOR FOR FURTHER BREAKDOWN. REINFORCING BARS IN THE BEAM CONNECTING TO EXTERIOR COLUMN TO REMAIN FOR ADDITIONAL SUPPORT IM-2M IM-2M IM-2M IM-2M BEING WITH SECTION AT MID SPAN. BREAK AWAY A VERTICAL GROOVE WITH SOME REINFORCING BARS REMAIN TO SUPPORT THE STRUCTURE

WALL TIE ANCHORED TO INTERIOR COLUMN OR BEAM

EXTERNAL R.C. WALL (VIEW FROM INSIDE)

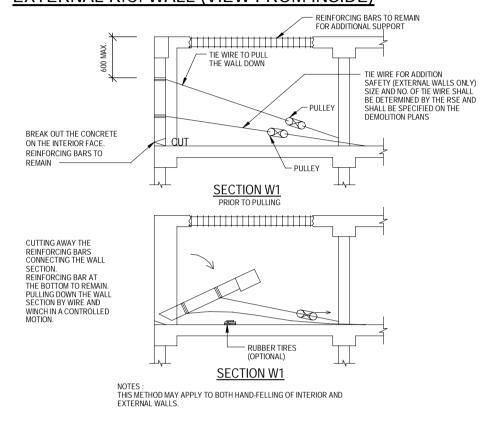

FELLING OF REINFORCED CONCRETE WALL

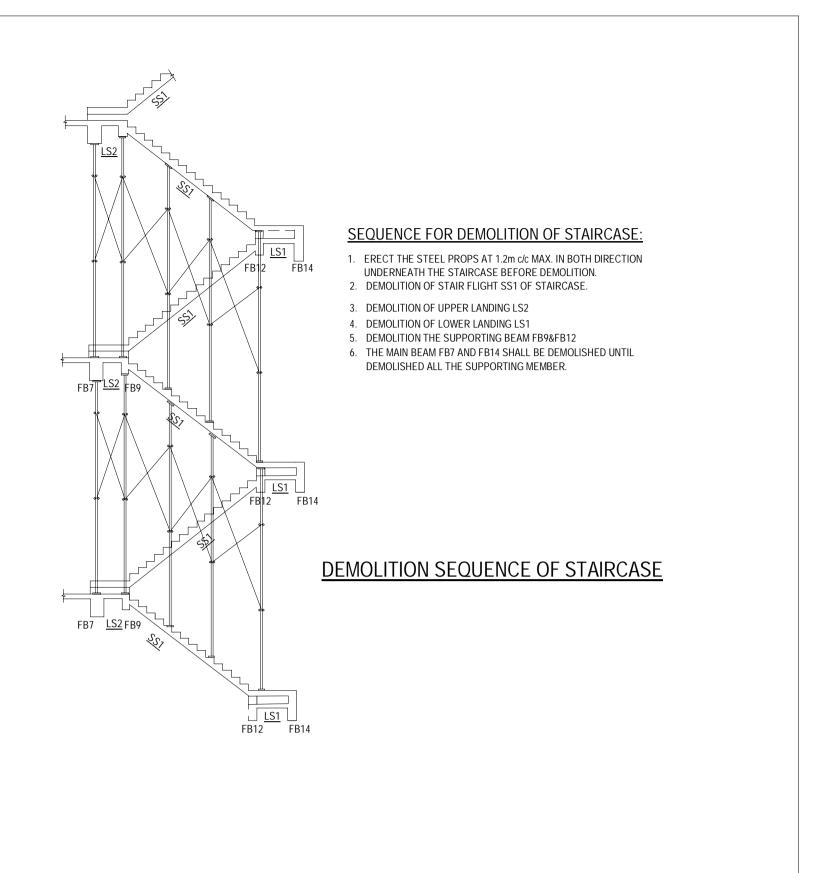

BIM REF		
	•	
REV	DATE	AMENDMENT
PROJECT S	I SAMPLE PRO	DJECT
2) SCALE		MOLITION WORKS (2 C
DRAWIN	G NO.	REV. NO.
D005		KEV. NO.
SOURCE		
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	90mm (V for COMI	V) x 40mm (H) space PANY LOGO
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	90mm (V for COMI	V) x 40mm (H) space PANY LOGO
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	for COMI	PANY LOGO /) x 60mm (H) space
	for COMI 90mm (V for AP/R:	PANY LOGO V) x 60mm (H) space SE/RGE's
	for COMI 90mm (V for AP/R:	PANY LOGO /) x 60mm (H) space
	for COMI 90mm (V for AP/R:	PANY LOGO V) x 60mm (H) space SE/RGE's
	for COMI 90mm (V for AP/R:	PANY LOGO V) x 60mm (H) space SE/RGE's
BD's Of	for COMI 90mm (V for AP/R:	PANY LOGO V) x 60mm (H) space SE/RGE's
BD's Of	90mm (V for AP/R: signature	PANY LOGO V) x 60mm (H) space SE/RGE's
BD's Of	90mm (V for AP/R: signature	PANY LOGO V) x 60mm (H) space SE/RGE's
BD's Of	90mm (V for AP/R: signature	PANY LOGO V) x 60mm (H) space SE/RGE's
BD's Of	90mm (V for AP/R: signature	PANY LOGO V) x 60mm (H) space SE/RGE's
BD's Of	90mm (V for AP/R: signature	PANY LOGO V) x 60mm (H) space SE/RGE's
BD's Of	90mm (V for AP/R: signature	PANY LOGO V) x 60mm (H) space SE/RGE's
BD's Of	90mm (V for AP/R: signature	PANY LOGO V) x 60mm (H) space SE/RGE's
BD's Of	90mm (V for AP/R: signature	PANY LOGO I) x 60mm (H) space SE/RGE's I and stamp chop
BD's Of	90mm (V for AP/R: signature	PANY LOGO I) x 60mm (H) space SE/RGE's I and stamp chop I) x 150mm (H) space approval stamp /
BD's Of	90mm (V for AP/R: signature	PANY LOGO I) x 60mm (H) space SE/RGE's I and stamp chop I) x 150mm (H) space approval stamp / on of copies of
BD's Of	90mm (V for AP/R: signature	PANY LOGO I) x 60mm (H) space SE/RGE's I and stamp chop I) x 150mm (H) space approval stamp /
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GENERAL NOTES FOR HOARDING PLAN:

- DESIGN AND CONSTRUCTION SHALL COMPLY WITH:
 a. HONG KONG BUILDING (CONSTRUCTION) REGULATION.
 b. CODE OF PRACTICE FOR STRUCTURAL USE OF STEEL 2011.
 c. CODE OF PRACTICE FOR STRUCTURAL USE OF CONCRETE 2013.
- d. CODE OF PRACTICE FOR FOUNDATION 2017.e. CODE OF PRACTICE ON WIND EFFECTS IN HONG KONG 2019.
- ALL DIMENSIONS AND LEVEL ARE IN mm AND mPD RESPECTIVELY.
 THE CONTRACTOR SHALL CHECK ALL DIMENSIONS AS SHOWN ON

DRAWINGS AND ON SITE PRIOR TO THE CONSTRUCTION WORK IS

- PROCEEDED.

 4. ALL MATERIALS TO BE USED SHALL BE NEW.
- 5. LOADING/UNLOADING SHOULD BE CONFINED WITHIN THE SITE.
- 6. VEHICLES SHOULD NOT BE PLANNED TO QUEUE ON PUBLIC ROAD.
- 7. ADDITIONAL TIE-WIRE TO BE PROVIDED TO ENHANCE THE STABILITY OF THE HOARDING/COVERED WALKWAY DURING TYPHOON SEASONS.
- 8. DURING CONSTRUCTION THE STRUCTURE SHALL BE MAINTAINED IN STABLE CONDITION AND NO PART SHALL BE OVERSTRESSED.
- 9. LOCATION OF ALL UNDERGROUND UTILITIES SHALL BE DETECTED BY USING APPROPRIATE DETECTION EQUIPMENT AND DIGGING TRIAL PIT IF REQUIRED
- 10. ALL UNDERGROUND UTILITIES SHALL BE PROPERLY PROTECTED
- 11. THE HOARDING SHALL BE REMOVED AS SOON AS THE BUILDING WORKS IS COMPLETED

12. CLITHEFODDING SHALL BE REMOVE LUPON FEMOVAL DAH CARDING THE TRENCHES SHALL BE RACKHILLED TO THE SATISFACTION OF

- 13. SHOULD THE WORKS INVOLVE TREE FELLING OR TRANSPLANTATION, APPROVAL FROM DLO SHALL BE OBTAINED PRIOR TO COMMENCEMENT OF THE WORKS
- 14. A SAFETY CERTIFICATE SHALL BE SUBMITTED BY THE AP/RSE ANNUALLY AND UPON EXPIRY OF THE HOARDING PERMIT IF RENEWAL OF HOARDING IS REQUIRED
- 15. TRANSPORT DEPARTMENT SHOULD BE APPROACHED ON NECESSARY REMOVAL OF STREET FURNITURE, TRAFFIC SIGNS, SIGNALS MARKING, BUS STOPS, PARKING SPACES, ETC.
- 16. THE HOARDING, INCLUDING ITS FOUNDATION, MUST NOT OBSTRUCT THE ACCESS TO ANY UTILITY PIT COVER LOCATED WITHIN THE HOARDING
- 17. THE HOARDING SHALL NOT OBSCURE ANY TRAFFIC SIGNS OR TRAFFIC SIGNALS, WHERE RESITING/REMOVAL OF ANY TRAFFIC AIDS (SUCH AS TRAFFIC SIGNS, TRAFFIC SIGNALS, GUARDRAIL AND THE LINK), THE AP AND RSE SHALL BE RESPONSIBLE FOR ALL APPLICATION TO THE RELEVANT GOVERNMENT AUTHORITIES FOR ANY TEMPORARY RESITING OF TRAFFIC SIGNS/LAMP POSTS ETC. WHICH MAY BE OBSCURED BY THE HOARDING AND COVERED WALKWAY.
- 18. THE REQUIRED CLEAR WIDTH MUST NOT BE OBSTRUCTED IN ANY MANNER BY TRAFFIC SIGN, TEMPORARY SUPPORTS, SCAFFOLDINGS OR THE LIKE.
- 19. WHERE THE HOARDING ARE ERECTED ON THE CARRIAGEWAY AND PEDESTRIAN, THERE SHOULD BE NO OBSTRUCTION TO THE FLOW OF DRAINAGE CHANNELS AND GULLIES OF THE ROAD.
- 20. EXISTING LAMP POLE SHOULD BE MAINTAINED AND UNOBSTRUCTED.


NOTES FOR MOE:

NOTICE SHOULD BE MADE FOR THE CHANGE OF MEANS OF ESCAPE (MOE) TO THE OCCUPIERS.

2. STEP CROEDING DOOP SHOT ER FRANC BINOP MELI DURING ORERATION OF WORK SHOR TO PROVIDE ALERNATIVE NOT.

- 3. SUFFICIENT DIRECTIONAL AND EXIT SIGNS SHOULD BE PROVIDED TO INDICATE THE REVISED MOE. THE SIGNS SHOULD COMPLY WITH CODE OF PRACTICE FOR MINIMUM FIRE SERVICE INSTALLATIONS AND EQUIPMENT.
- 4. MOE SHALL COMPLY WITH FS CODE 2011.



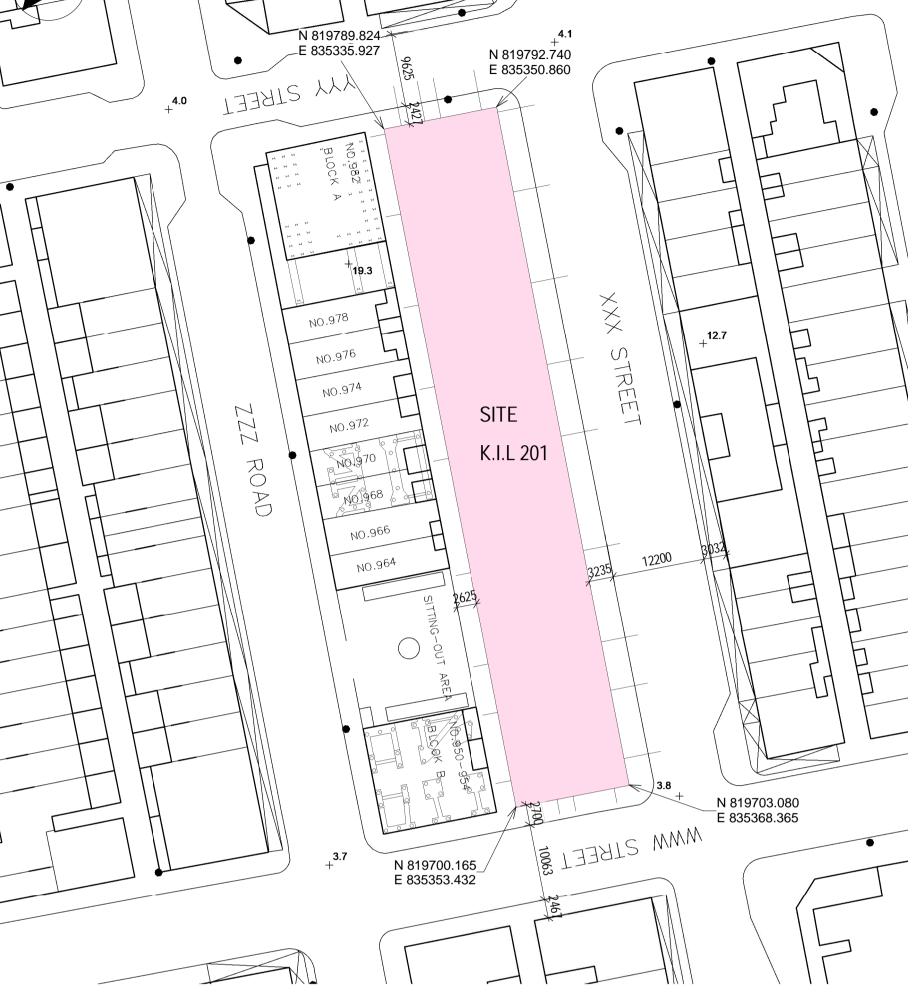

BLOCK PLAN 1:500 REV DATE AMENDMENT
PROJECT
CIC SAMPLE PROJECT

DRAWING TITLE
HOARDING LAYOUT PLAN

SCALE As indicated@A1

DRAWING NO. REV. NO.

SOURCE ---

BD REF

BIM REF


90mm (W) x 40mm (H) space for COMPANY LOGO

90mm (W) x 60mm (H) space for AP/RSE/RGE's signature/ and stamp chop

BD's OFFICAL USE

90mm (W) x 150mm (H) space for BD's approval stamp / certification of copies of approved plans (PNAP ADM-10 APP A)

XXX STREET

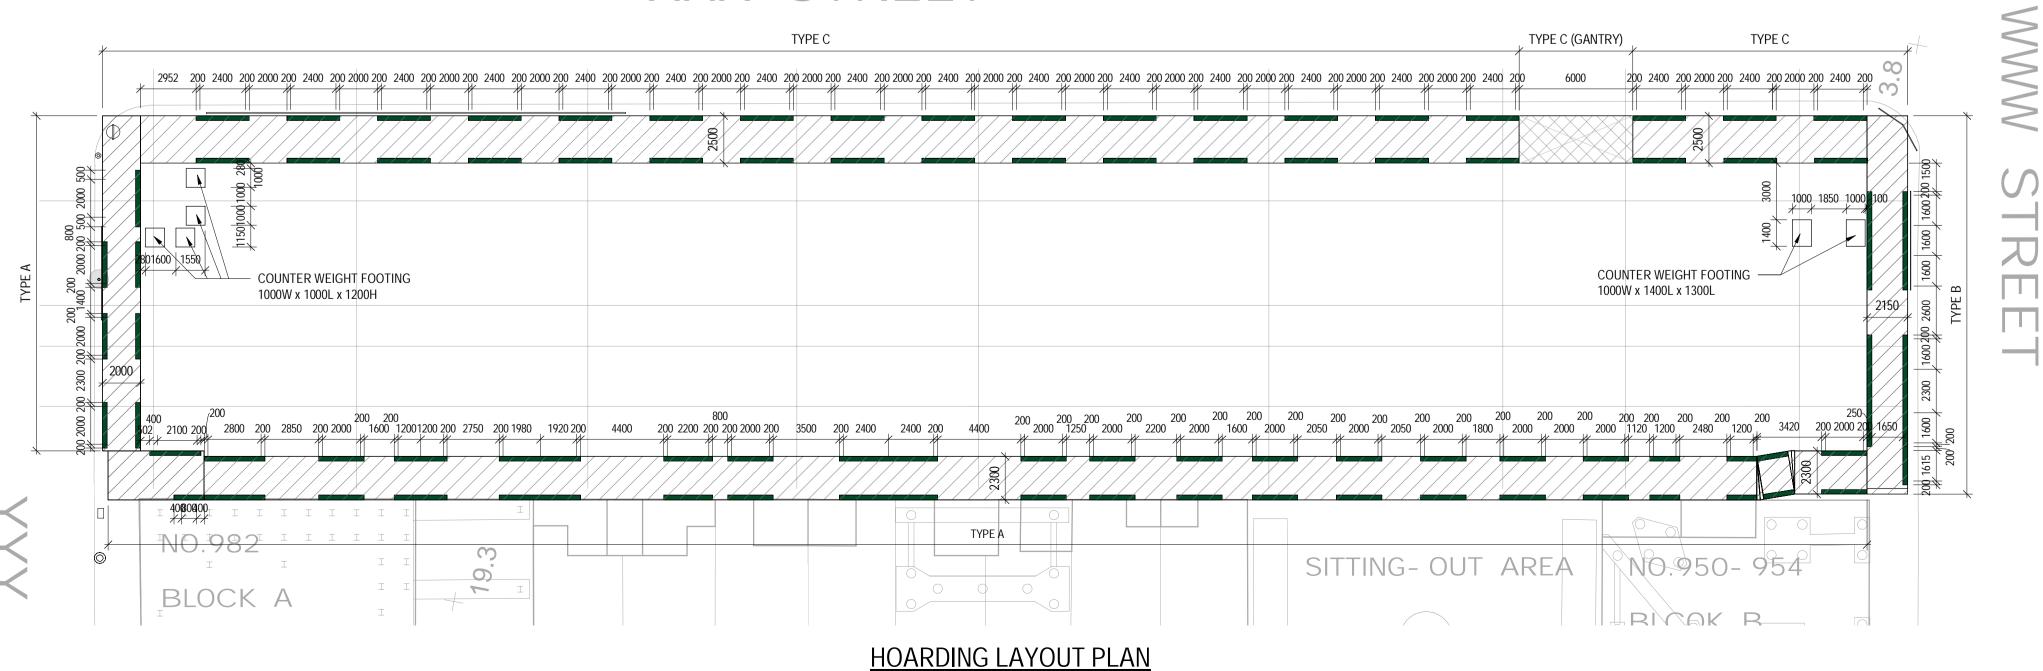

1:200

